Residential Study Group Agenda October 22, 2016


Attached please find plans from architects and engineers and dimensional and density reviews from Inspectional Services for three properties we will visit on Saturday. Our tour will begin at 96 Oakland Ave, continue to 62 Kensington Park, and finish at 9-11 Park Street. These cases are illustrative of the many issues we are interested in as a group. Each site visit will include a brief presentation by Inspectional Services (Mike) and highlights of challenging and positive aspects of each case. We will then have time to ask questions and discuss each case as a group.

96 OAKLAND AVENUE

DEMOLITION OF SINGLE FAMILY DWELLING, CONSTRUCTION OF NEW SINGLE FAMILY DWELLING.

| LOT COVERAGE: | 16.44% |
|------------------------------|--------------|
| TOTAL GROSS FLOOR AREA: | 3463 SQ FT |
| OPEN SPACE REQUIRED: | 1038.9 SQ FT |
| OPEN SPACE PROVIDE: | 4750 SQ FT |
| OPEN SPACE PERCENTAGE: | 76.52% |
| BUILDING HEIGHT (PROPOSED) | 32' +/- |
| LOT SLOPE: (OVERALL) | 2.9% |
| LOT SLOPE: (OPEN SPACE ONLY) | 1.09% +/- |
| ATTIC GFA (523 SQ FT) | 43.43% |
| SLOPE OF DRIVEWAY PROPOSED | NA |

| , | 96 DAKLAND ADENUE |
|---------|----------------------------------|
| 16.44 % | Lot Coverage: Liverage 6x18 108 |
| | 36×36 1296 |
| | 12x 20 240 |
| | 1644 |
| 3463 × | GFA BARYENT 20X30 600 |
| | post Floor 1204 |
| | From Flow 30x36 1060 |
| . — | 12x 20 24p |
| | ATTIC 26 × 12 312 |
| | 4.5 x 6 27 |
| | 3463 |
| - | Open Lince Zegvices 1038.9 B |
| 137 % | Open Sonce Available 28% 4750 10 |
| | |
| | |
| 32' +/- | Building Height (Digo 25%) |
| 2.9 % | Lot Slope OverAll |
| 1.09 % | LOT Slope Open Space Oxly |
| | |
| | |

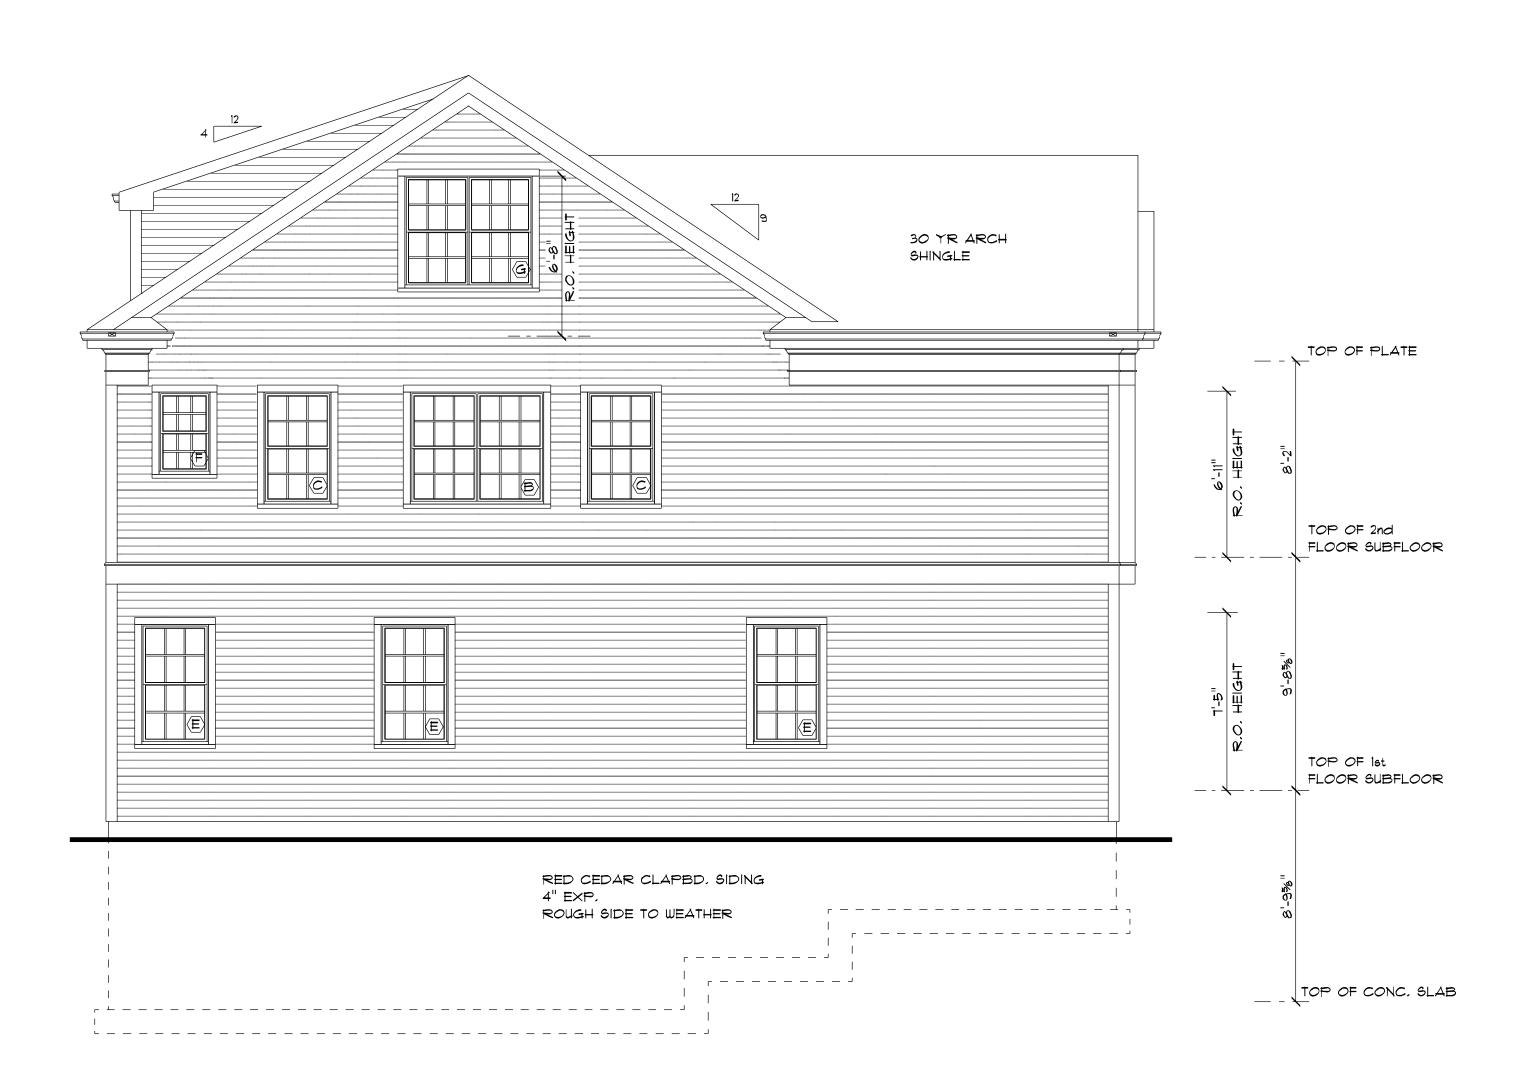

PROPOSED LEFT SIDE ELEVATION

JELD-WEN SITEINE EX WINDOW SCHEDULE

| REF | PRODUCT CODE | R.O. SIZE | GRILLE | TRIM | REMARKS | COUNT |
|-----|--------------|-------------------------|--------|-------|-------------------------|-------|
| Д | ECD3360-2 | R.O. 67 1/2" x 60 3/4" | 6 ov 6 | 5/4×4 | | 1 |
| В | ECD3356-2 | R.O. 67 1/2" x 56 3/4" | 6 ov 6 | 5/4×4 | | 3 |
| С | ECD3356 | R.O. 34 1/8" × 56 3/4" | 6 ov 6 | 5/4×4 | | 5 |
| D | ECD2944 | R.O. 30 1/8" × 44 3/4" | 6 ov 6 | 5/4×4 | | 3 |
| E | ECD3360 | R.O. 34 1/8" × 60 3/4" | 6 ov 6 | 5/4×4 | | 3 |
| F | ECD2540 | R.O. 26 1/8" × 40 3/4" | 6 ov 6 | 5/4×4 | TEMP. GL. | 1 |
| G | ECD2956-2 | R.O. 59 1/2" × 56 3/4" | 6 ov 6 | 5/4×4 | | 2 |
| Н | ECC2442-3 | R.O. 72 3/4" × 42 3/4" | 2w, 3h | 5/4×4 | TRIPLE CASEMENT | 1 |
| J | ECA3024-2 | R.O. 60 3/4" × 24 3/4" | 3w, 2h | 5/4×4 | DOUBLE AWNING, TEMP GL. | 1 |
| K | ECD3360-3 | R.O. 100 7/8" × 60 3/4" | 6 ov 6 | 5/4×4 | | 1 |
| L | ECD2536 | R.O. 26 1/8" x 36 3/4" | 6 ov 6 | 5/4×4 | | 1 |

-LOW E ARGON FILLED -SDL DIVIDED LITES -PROVIDE SCREENS

-WHITE HARDWARE -CLAD COLOR: PER CONTRACTOR

JELD-WEN SITELINE EX DOOR SCHEDULE

| REF. | PRODUCT CODE | R.O. SIZE | GRILLE | TRIM | REMARKS | COUNT |
|------|--------------|--------------------|--------|-------|-----------------------------------|-------|
| 1 | PRC16W28611 | R.O. 32 3/8" x 83" | 3w, 5h | 5/4×4 | INSWING DOOR, TEMP GL., LH HINGED | 1 |
| 2 | PRC16W28611 | R.O. 32 3/8" x 83" | 3w, 5h | 5/4×4 | INSWING DOOR, TEMP GL., RH HINGED | 1 |

-LOW E ARGON FILLED

-PROVIDE SCREENS -DOOR HARDWARE COLOR: PER CONTRACTOR -CLAD COLOR: PER CONTRACTOR

TYPICAL EXTERIOR WALL CONSTRUCTION

-WINDOWS: JELD-WEN SITELINE EX CLAD -WINDOW & DOOR HEADERS-AS PER FRAMING PLAN, INSULATED AS ALLOWED BY SIZING

-SIDING- RED CEDAR CLAPBOARD SIDING -EXTERIOR SHEATHING: 1/2" ZIP SYSTEM WITH TAPED SEAMS -STUDS & PLATES: 2x6 @ 16" O.C.

-EXTERIOR WALL INSULATION: R-21 MINIMUM, PER BUILDER -INTERIOR FINISH: 1/2" BLUEBOARD W/SKIMCOAT PLASTER SMOOTH

TYPICAL FLOOR CONSTRUCTION

-SUBFLOOR: 3/4" T&G ADVANTECH SUBFLOOR GLUED & NAILED -FLOOR JOISTS AS PER STRUCTURAL FRAMING PLANS -SILLS: (2) 2x6 PRESSURE TREATED -SILL SEALER: 5" FOAM TYPE -INSULATION: R-30 MINIMUM, TYPE PER BUILDER

TYPICAL ROOF CONSTRUCTION

-SHINGLES" 30 YEAR ARCHITECTURAL, COLOR BY OWNER/BUILDER -ICE & WATER BARRIER: TO EXTEND ALONG EAVES TO A POINT 24" HORIZONTAL FROM EXTERIOR WALL EDGE # 18" EACH SIDE OF VALLEYS

-DRIP EDGE: METAL -ROOF SHEATHING: 1/2" ZIP SYSTEM TONGUE AND GROOVE WITH TAPED SEAMS

-ROOF RAFTERS: SIZE PER STRUCTURAL FRAMING PLANS -ROOF INSULATION: R-38 MINIMUM, TYPE PER BUILDER

ABBREVIATIONS air conditioning masonry opening ALUM 00 on center AP ash pit overhead BD board OPG opening BLK overhang PAN cast iron PD pocket door CLG plywood COL powder room CONC per square foot concrete per square inch dimension parallel strand lumber down risers \square W dishwasher REF refridgerator ELEC REINF reinforcing electric EQUIP REQ equipment required EXP exposed FIBGL fiberglass rough opening square foot/feet STL steel FTG footing STOR storage trash compactor galvinized ground fauilt interrupter T#G tounge and groove GL TEMP tempered GYP gypsumtrimmed opening HDR header tread run INSUL TYP insulation typical LAUN laundry VAN ∨anity LIN washer laminated veneer lumber with MAXmaximum WD wood medicine cabinet wire mesh waterproof

ENGINEERS PLAN


MIR

* ARCHITECTURAL PLANS ONLY

mirror

* STRUCTURAL PLANS TO BE PROVIDED BY CONTRACTOR * PLANS DESIGNED IN ACCORDANCE WITH 180CMR 8TH EDITION * GRADES SHOWN ARE APPROXIMATE, FINAL GRADES PER

9/14/2016 ATTIC DORMER REVISIONS: SHEET A/1 * WINDOW SCHEDULE * LEFT ELEVATION SHEET A/2 * ELEVATIONS SHEET A/5 * ATTIC PLAN SHEET A/8 * SECTION

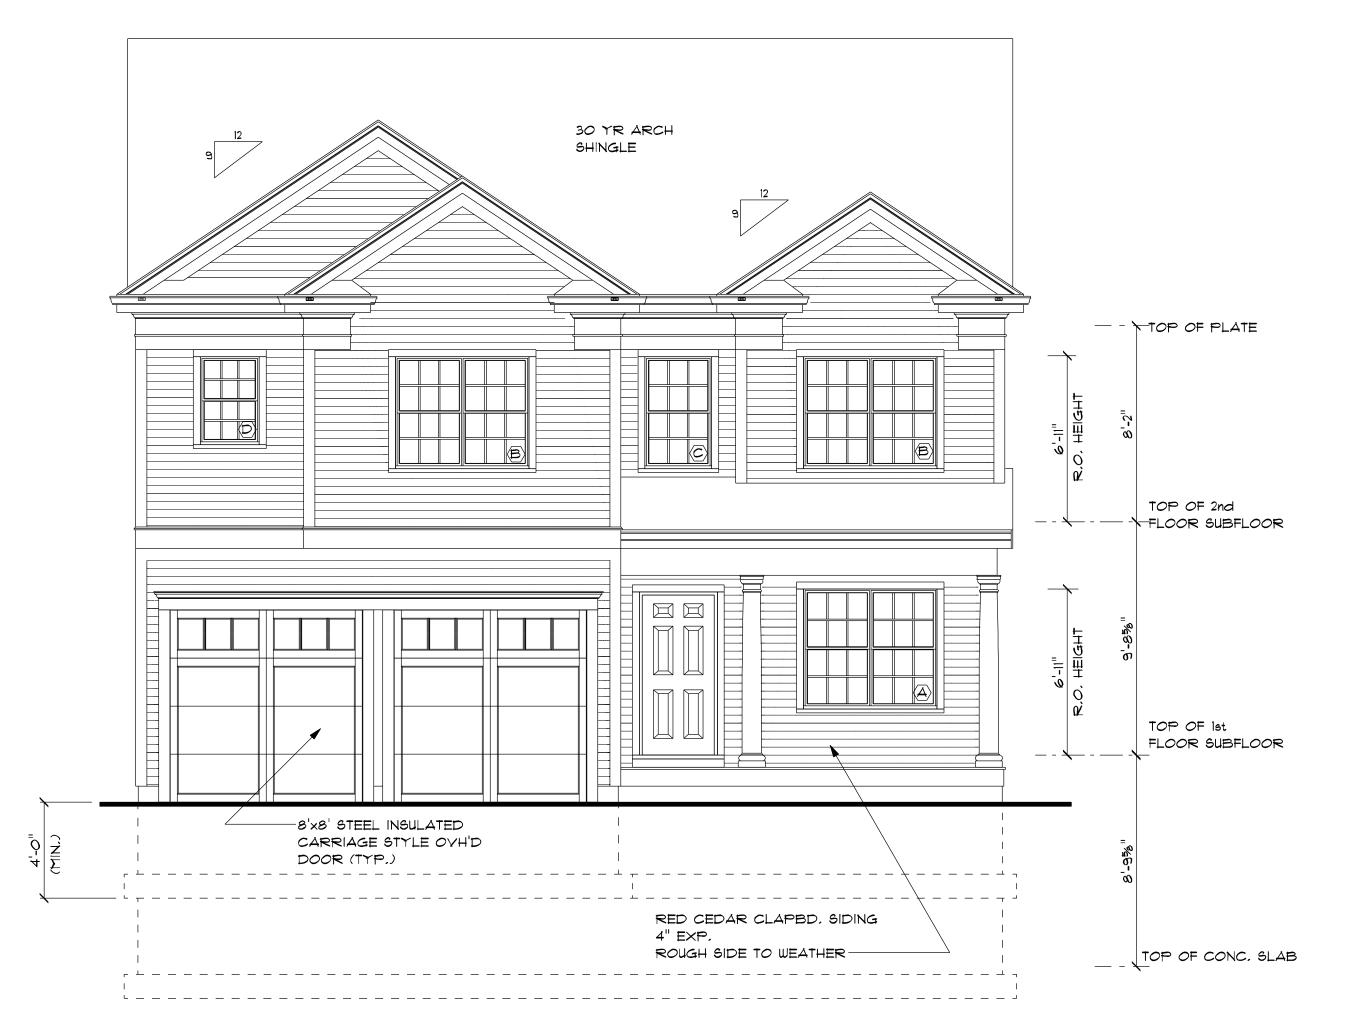


PROPOSED FRONT ELEVATION


OME

REVISIONS 9/14/2016 DRAWN CHECKED DATE 8/22/2016

SCALE 1/4"=1'-0" JOB NO.

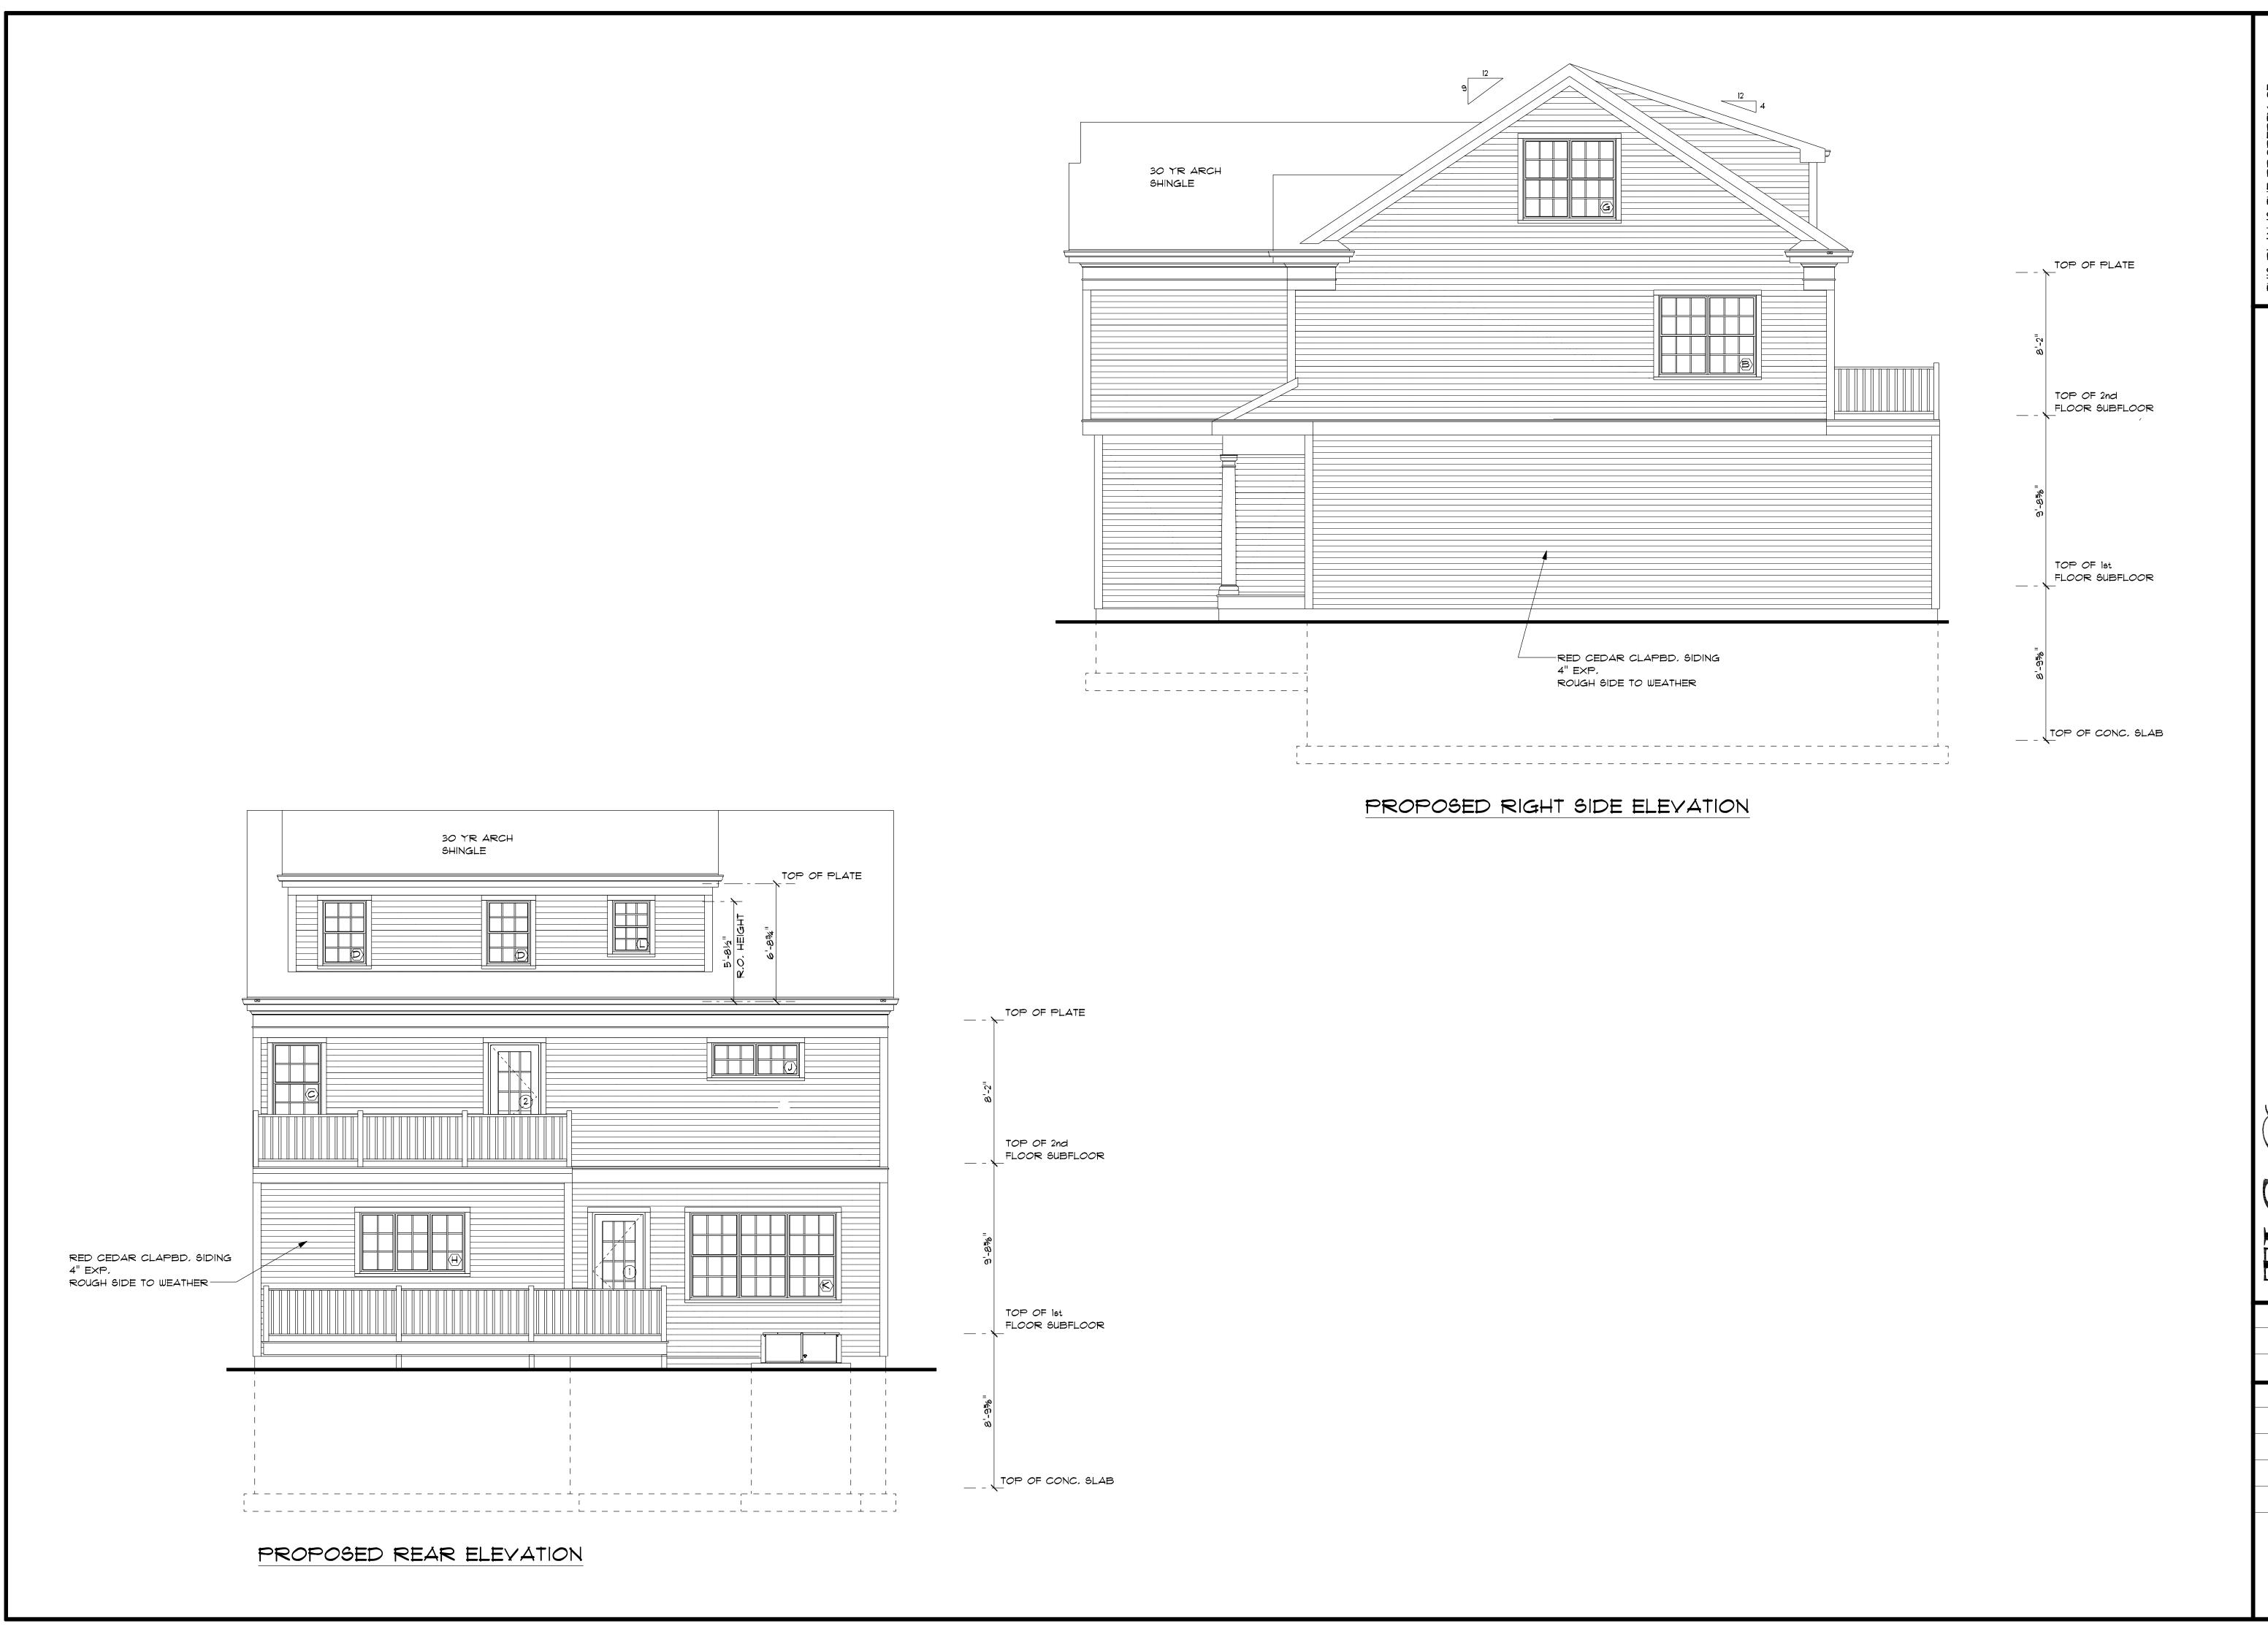

REVISIONS 9/14/2016 DRAWN WHP CHECKED DATE 8/22/2016 1/4"=1'-0" JOB NO.

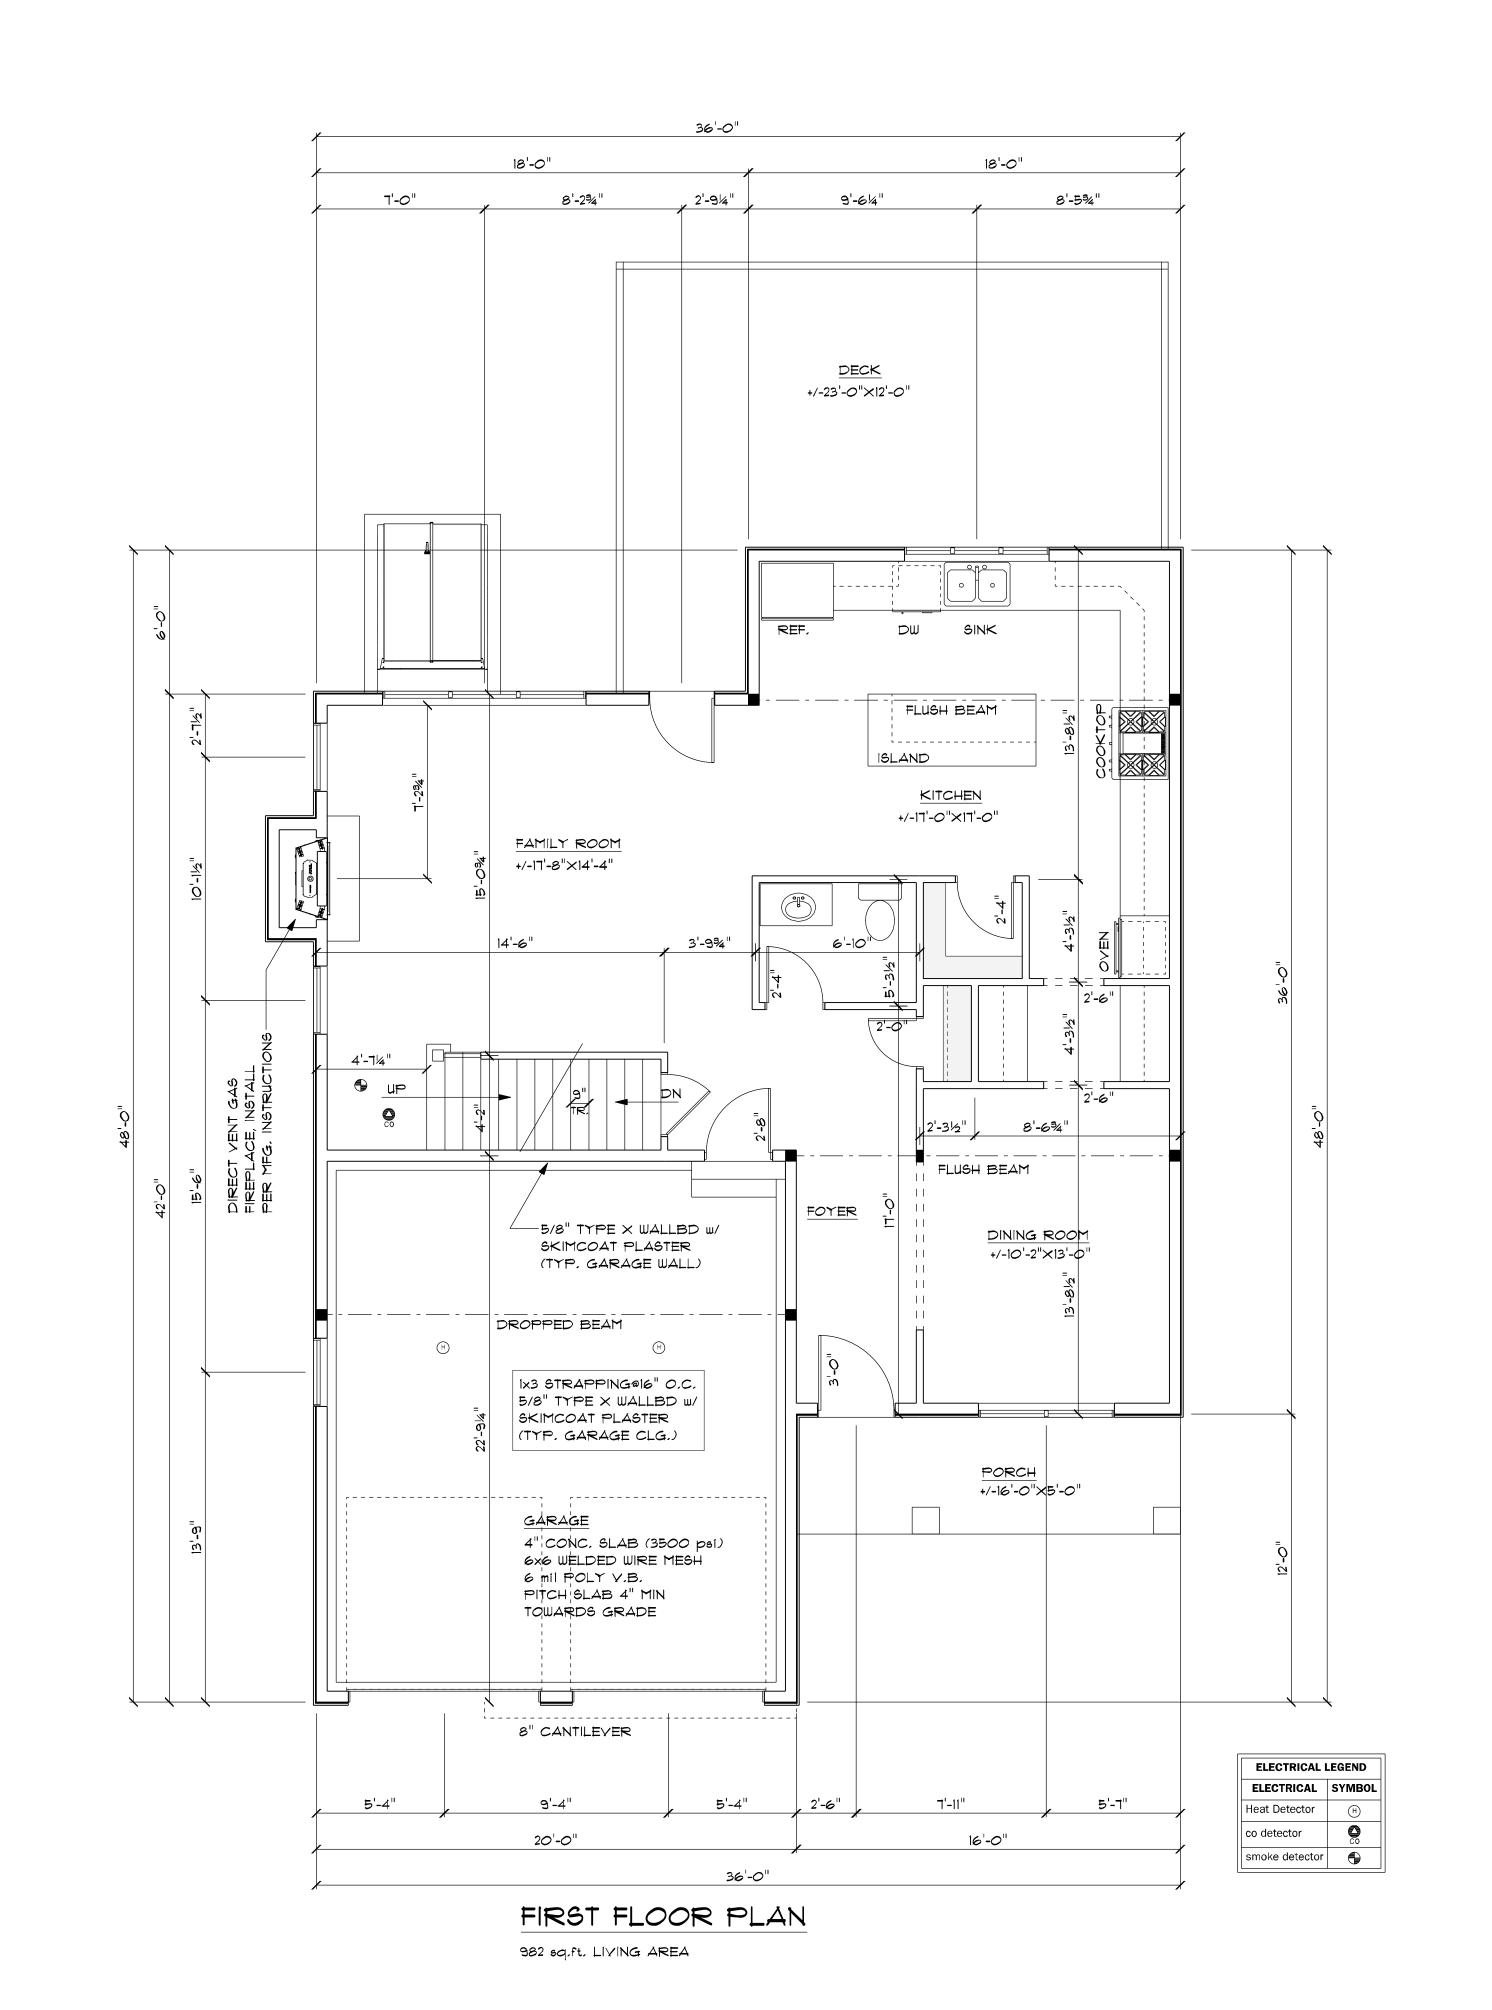


REVISIONS

DRAWN WHP CHECKED DATE

8/22/2016 SCALE 1/4"=1'-0" JOB NO.

SHEET

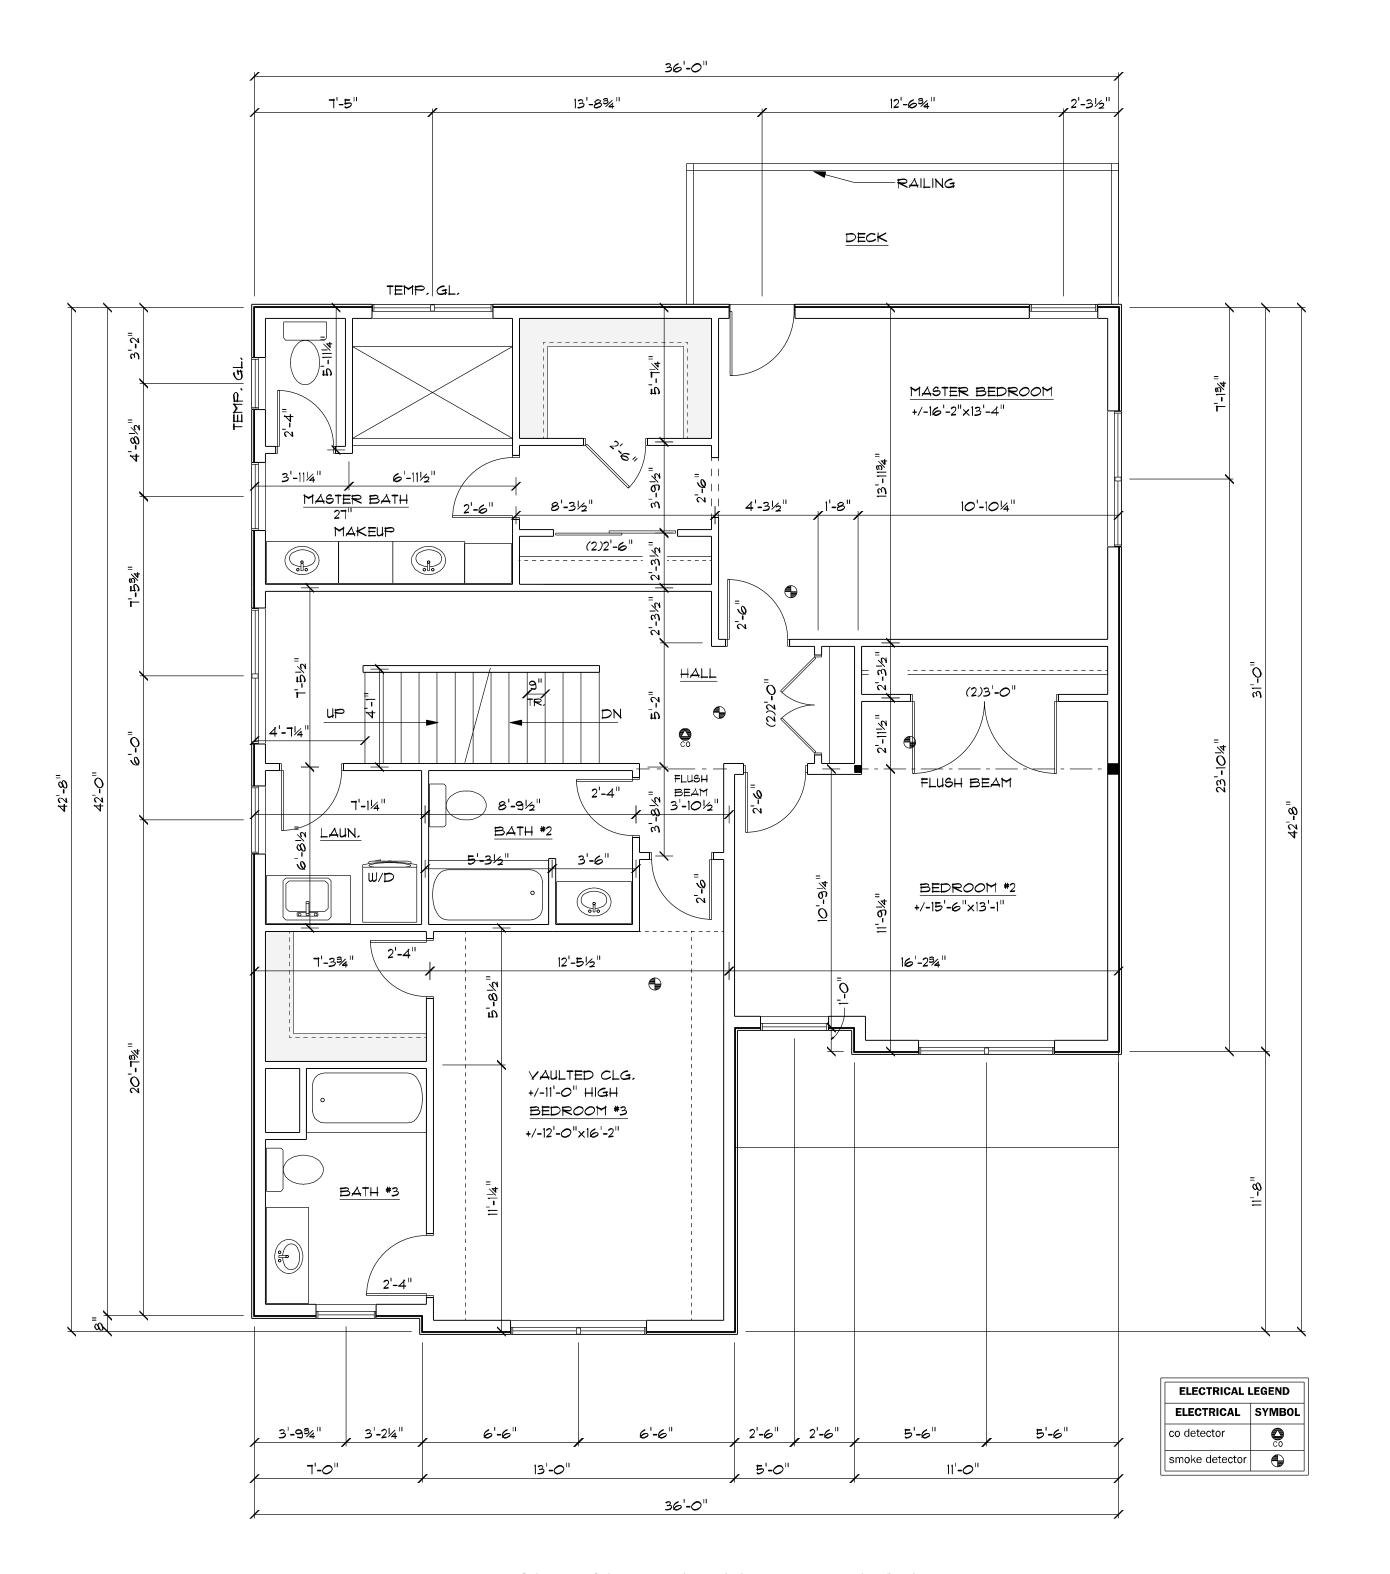

PROPOSED SECOND FLOOR PLAN

1339 eq.ft. LIVING AREA

96 OAKLAND STREET

otal living concepts design

REVISIONS


REVISIONS

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> DATE 8/22/2016 \$CALE 1/4"=1'-O" JOB NO.

SHEET




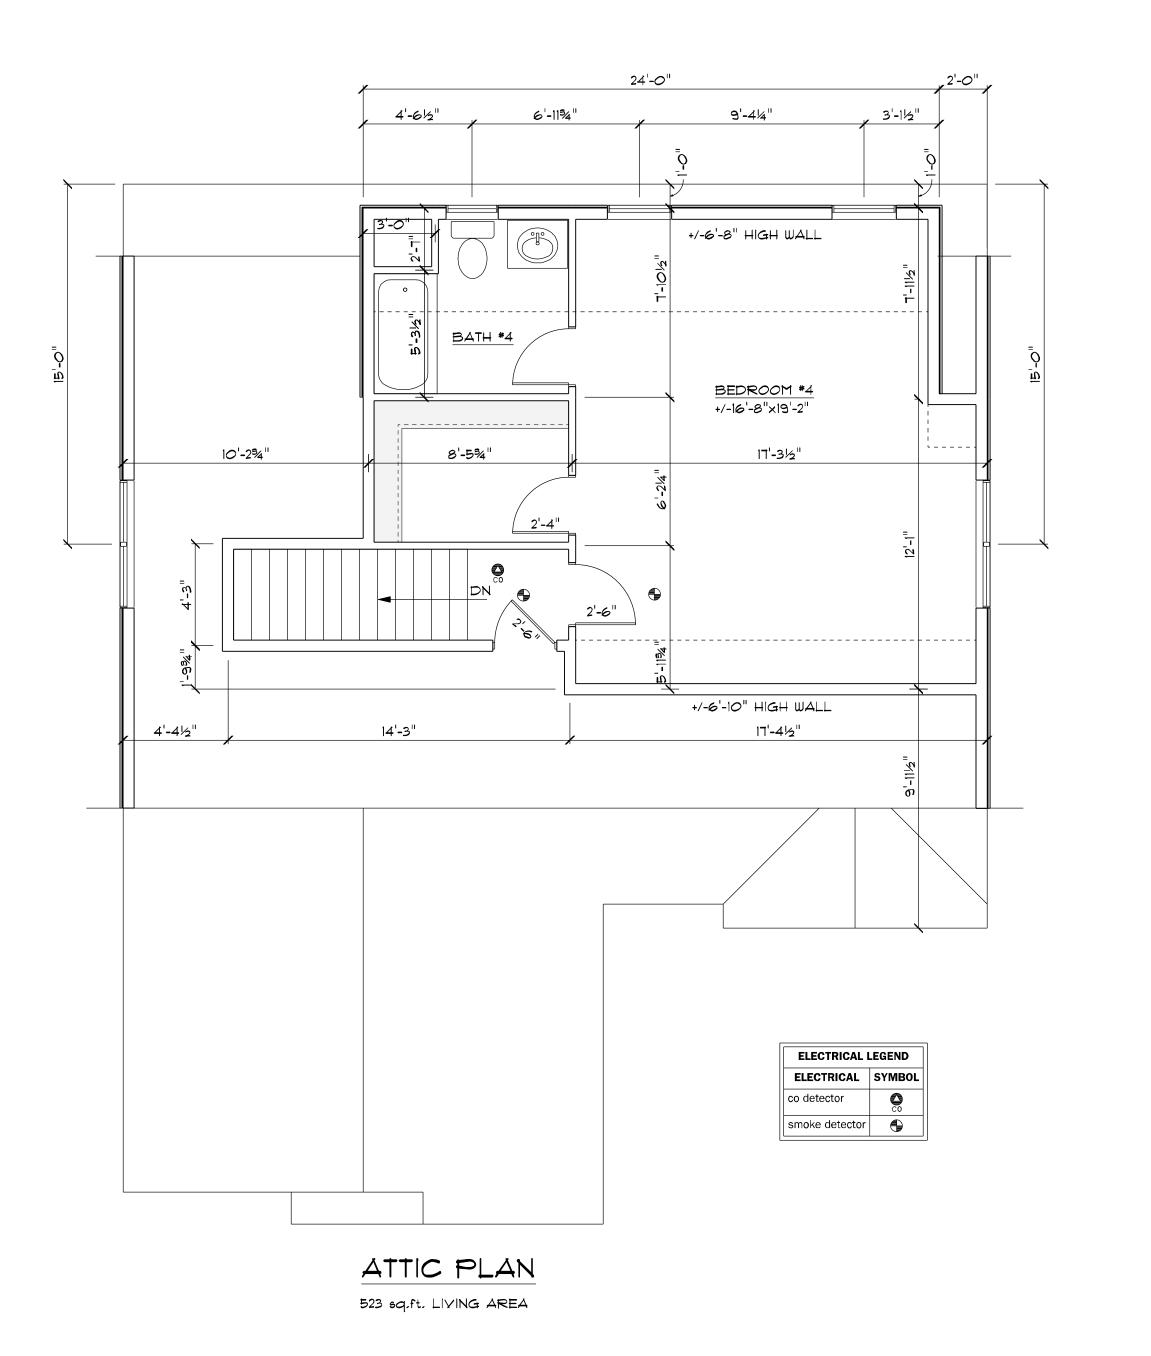

REVISIONS 9/14/2016

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DATE 8/22/2016 SCALE 1/4"=1'-0" JOB NO.

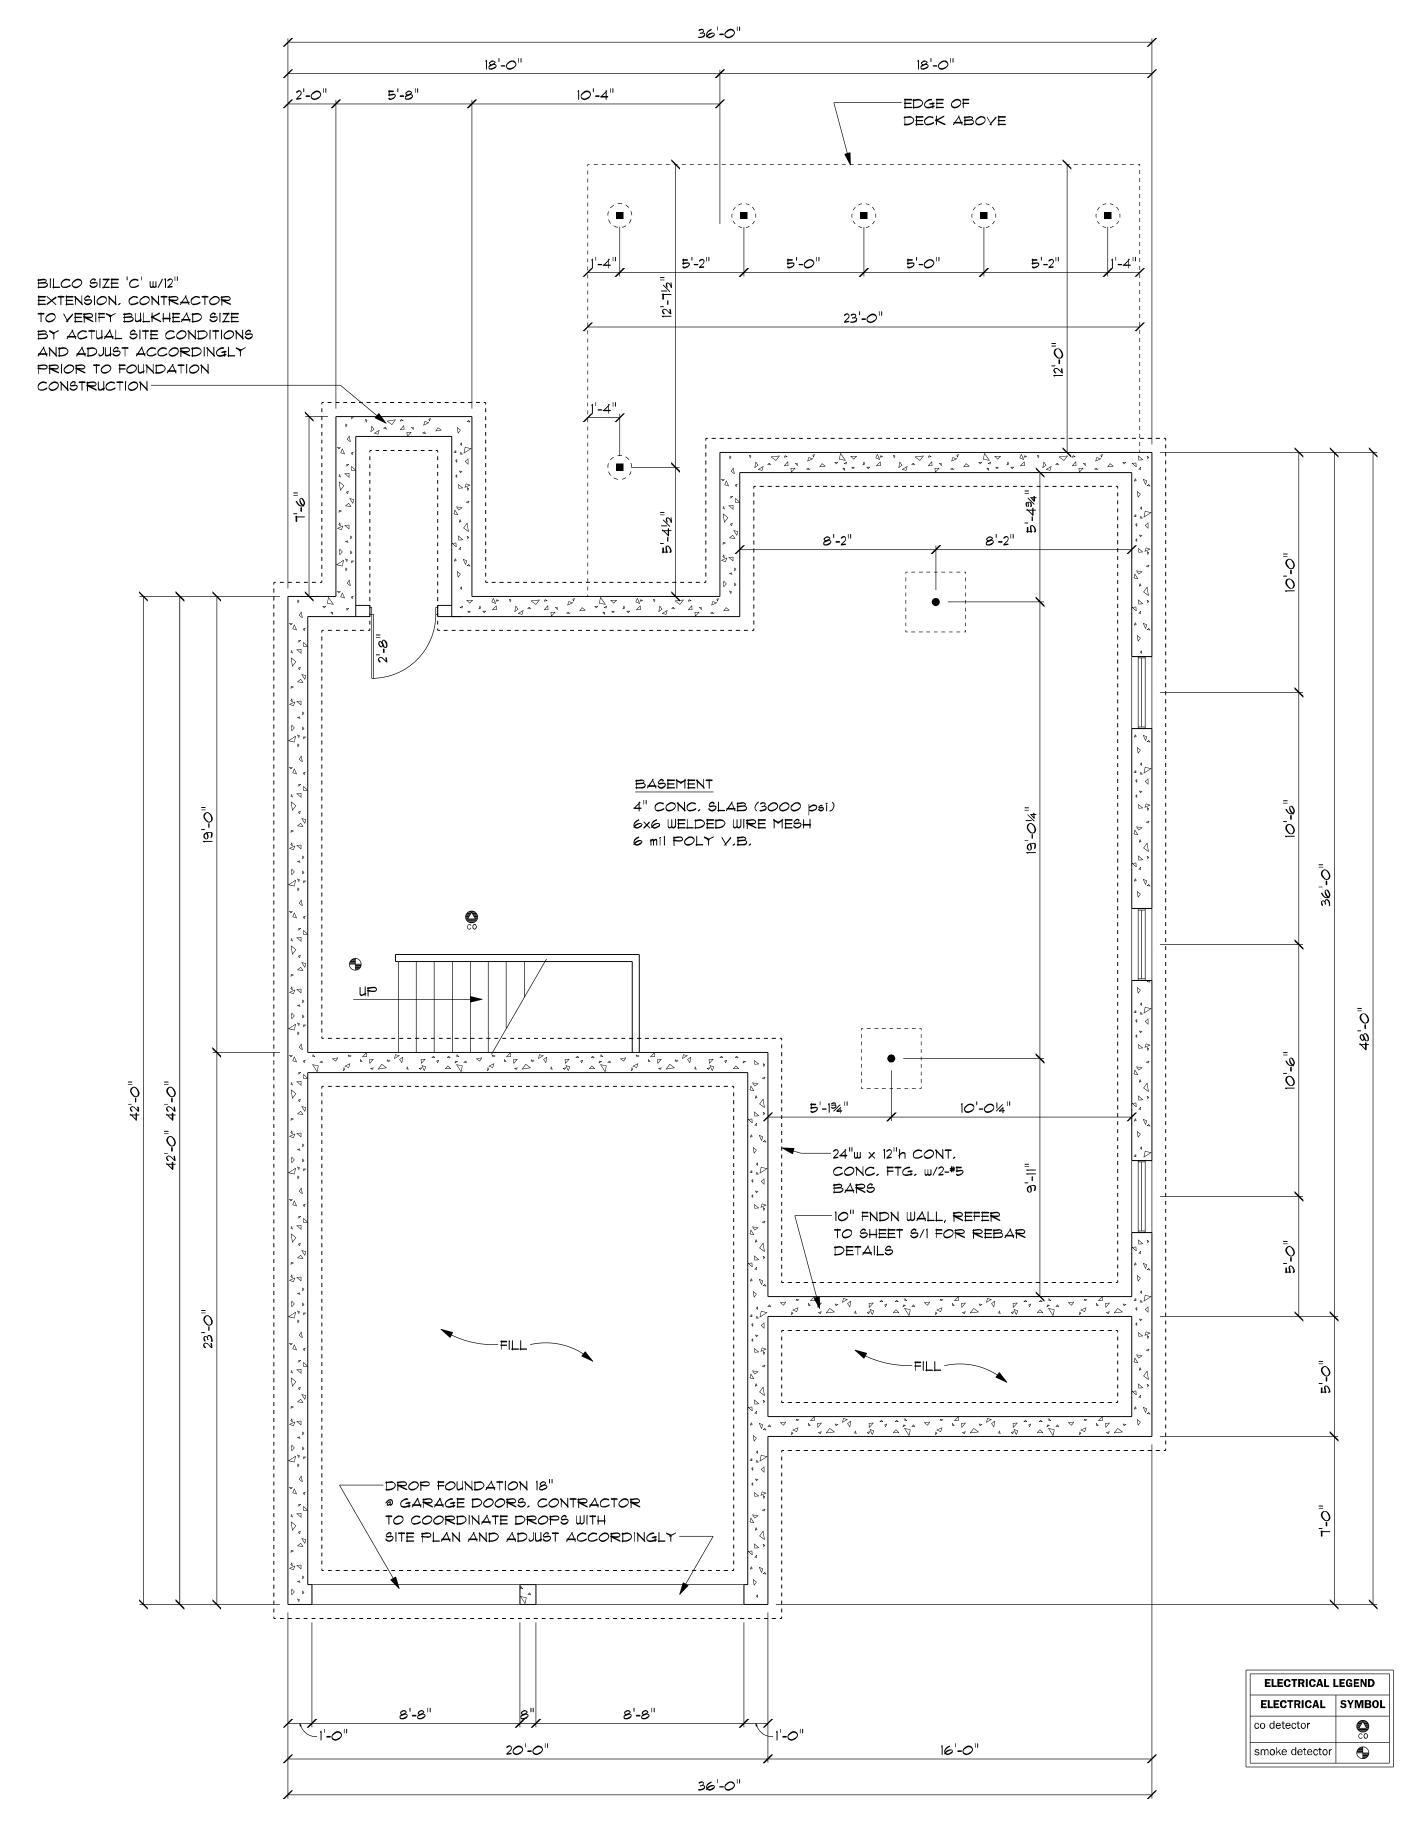


FOUNDATION PLAN

REVISIONS

DRAWN WHP CHECKED

DATE 8/22/2016 1/4"=1'-0" JOB NO.

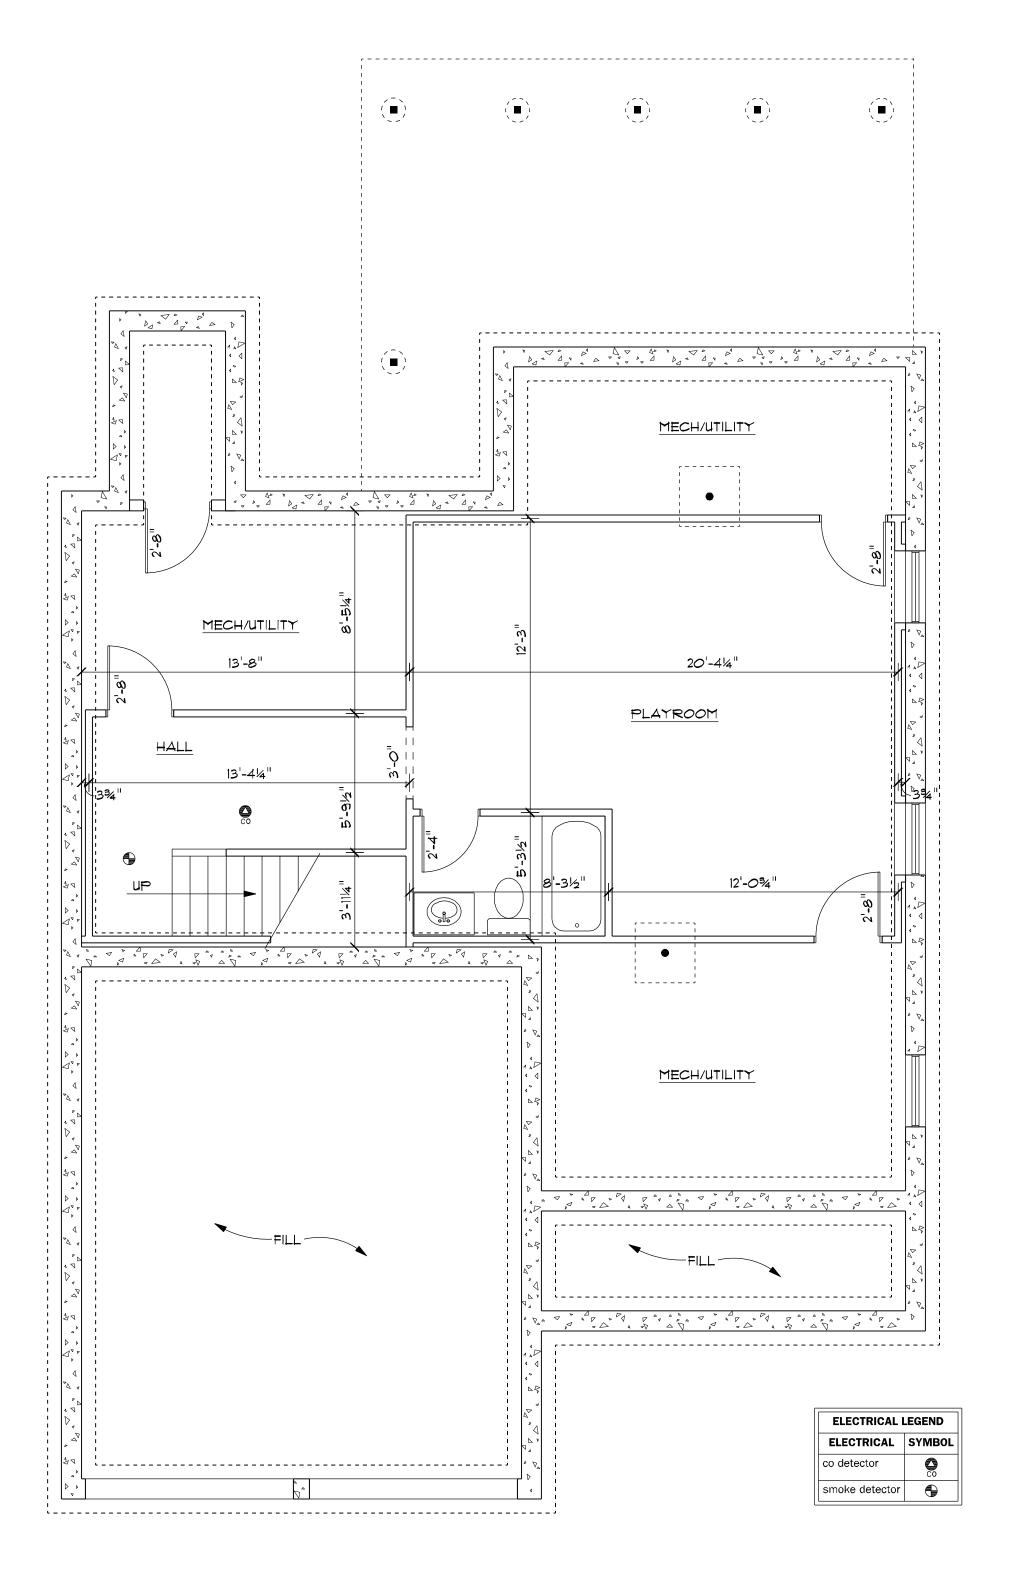

LOWER LEYEL PLAN


REVISIONS

DRAWN WHP CHECKED

DATE 8/22/2016

SCALE 1/4"=1'-0"

JOB NO.

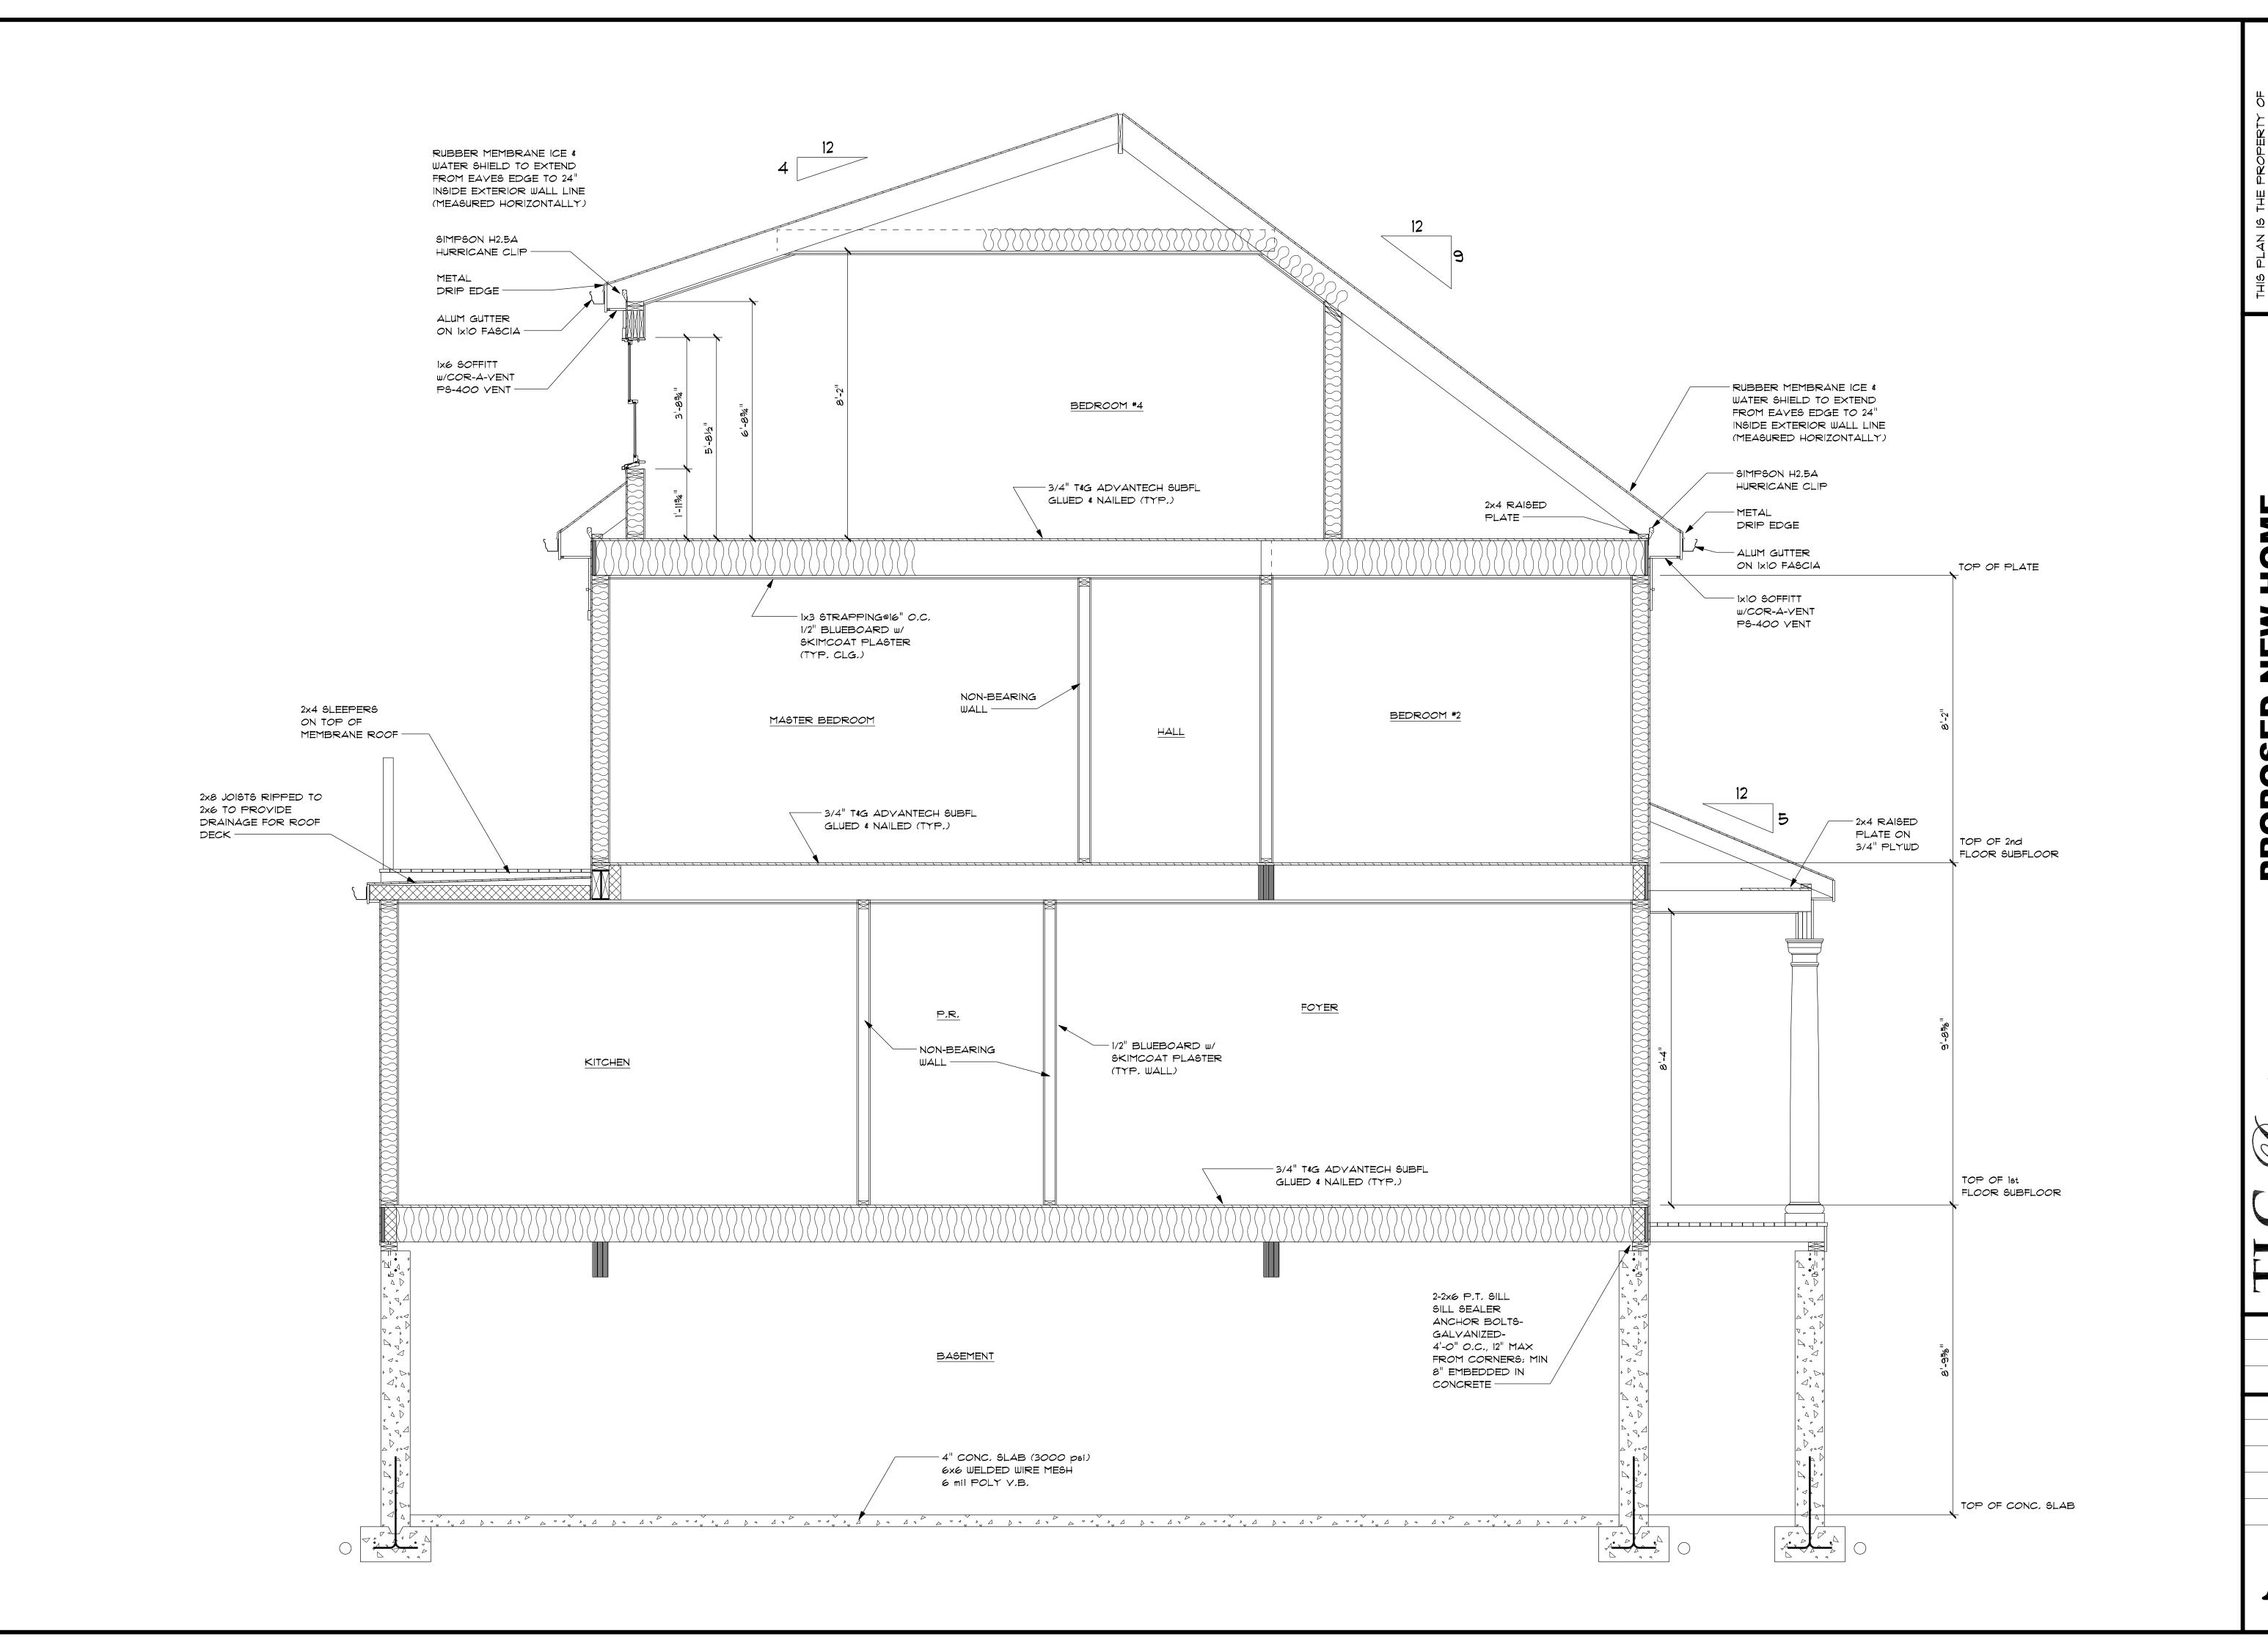

HOME

REVISIONS 9/14/2016 DRAWN WHP CHECKED DATE 8/22/2016

SCALE 1/2"=1'-0" JOB NO.

62 KENSINGTON PARK

DEMOLITION OF SINGLE FAMILY DWELLING, CONSTRUCTION OF NEW SINGLE FAMILY DWELLING.

| LOT COVERAGE: | 25.3% |
|------------------------------|--------------|
| TOTAL GROSS FLOOR AREA: | 3793 SQ FT |
| OPEN SPACE REQUIRED: | 1137.9 SQ FT |
| OPEN SPACE PROVIDE: | 1875 SQ FT |
| OPEN SPACE PERCENTAGE: | 49.4% |
| BUILDING HEIGHT (PROPOSED) | 34' 6" |
| LOT SLOPE: (OVERALL) | 8.12% |
| LOT SLOPE: (OPEN SPACE ONLY) | 6% +/- |
| ATTIC GFA (680 SQ FT) | 44.73 % |

This card must be visible from the street and accessible for the inspector to sign.

Town of Arlington BUILDING CARD



Inspector of Buildings or Local Building Inspector

| Job Address: 62 KENSINGTON PARK | | |
|---|---------------------------------------|------------------------|
| Nature of Work: CONSTRUCT NEW SI | NGLE FAMILY DWELLING | |
| Conditions: AS BUILTS REQUIRED FOR C | COMPLIANCE WITH SECTION 6.00 | ~ |
| Conditions: No Bole to NE GOINE DY ON C | CIM ENTICE VITTI CECTION 6,60 | |
| Building Permit No.: B23179 | | Date Issued. 9-14-2016 |
| Junor. CHEN | | |
| Contractor: CARMINATI | | |
| | | } |
| - 1 | nspector must sign all applicable s | paces |
| Inspection | Approved | 10 |
| mspection | Approved | Not Approved |
| EXCAVATION, SETBACKS, & FOOTING FORMS | 1 | |
| | A | |
| | Pour no concrete until above is sig | gned |
| FOUNDATION, DAMPPROOFING, | 1/ | |
| & PERIMETER DRAINS | | |
| Do r | not frame until above is signed and | checked. |
| | built plot plan is filed with Buildin | |
| UNDERGROUND ELECTRICAL | | |
| UNDERGROUND PLUMBING/GAS | | |
| ROUGH ELECTRICAL | | |
| ROUGH PLUMBING | | |
| (Above must be signed prior | - | I. |
| to framing inspection) | | |
| FRAMING | 1 | |
| INSULATION | | |
| C | over no work until above has been s | hennie |
| | | |
| FINAL ELECTRICAL | | |
| FINAL PLUMBING | | |
| FINAL GAS. | | |
| FINAL MECHANICAL | | |
| FIRE DEPARTMENT APPROVAL | | |
| (Above must be signed prior to final building inspection) | | |
| | | |

(781) 316-3390

62 Kensing TOH



Town of Arlington
Inspectional Services Department
51 Grove Street
Arlington, Massachusetts 02476
781-316-3390
www.arlingtonma.gov

As built plot plan requirements prior to issuance of Certificate of Occupancy

As deemed necessary by the Building Official, the following may be required for review as part of the certified plot plan prior to issuance:

Building Height - (max 35' from average grade of structure in lots with slope of 5% grade or more.)

Stories - calculations showing measurements for stories. (basement and attic)

Gross Floor Area - calculations showing total GFA as defined in Zoning Bylaw.

Open Space - calculations showing required usable and open space requirements based on total

Parking spaces - show placement of required spaces.

STRUBLE ENGINEERING, LLC

603 Main Street
Reading, MA 01867-3002
(781) 942-3845

Town of Arlington – Inspectional Services Department 51 Grove Street Arlington, MA 02476-4602 September 26, 2016

Attention:

Richard Vallarelli, Building Inspector

Reference:

Foundation Conditions for Addition and Renovations

62 Kensington Park Arlington, MA 02476

Dear Mr. Vallarelli:

I am writing to attest to the structural integrity of the foundation revisions made to the Contract Drawings prepared by *Chongzi Chen, Architect* for the referenced property. Excavation for the foundations revealed subsurface ledge at the intended footing locations which I observed during a site visit on September 16, 2016. The rock was deemed sound for supporting the house footings and the footing depths satisfy the requirements of Code Section 5403.1.4.1-4 for frost protection. I made recommendations for pinning the foundation to the ledge to the Architect. These recommendations have been included in Mr. Chen's updated foundation drawings.

It is my opinion, therefore, that the foundations now seated on sound ledge satisfy the requirements of the Eighth Edition of the Massachusetts State Building Code. Please contact this office if you have any questions.

Very truly yours,

Jeffrey W. Struble, P.E.

Jeffry W. Stratte

Mass. Reg. No. 32141

STRUBLE ENGINEERING, LLC

603 Main Street Reading, MA 01867-3002 (781) 942-3845

Town of Arlington – Inspectional Services Department 51 Grove Street Arlington, MA 02476-4602

August 25, 2016

Attention:

Richard Vallarelli, Building Inspector

Reference:

Structural Framing for Addition and Renovations

62 Kensington Park Arlington, MA 02476

Dear Mr. Vallarelli:

I am writing to attest to the structural integrity of the framing and foundations for the new single family dwelling to be constructed on the referenced property as shown on the 07-03-16 Contract Documents submitted for permitting as prepared by *Chongzi Chen, Architect.* The framing and foundations were reviewed by this office and all revisions deemed necessary to satisfy Code requirements were transmitted to the architect for inclusion on the permit drawing set. I have reviewed the final presentation of the framing and foundations on those drawings and find them to conform to my revisions.

It is my opinion, therefore, that the structural systems shown for referenced project satisfy the requirements of the Eighth Edition of the Massachusetts State Building Code. Please contact this office if you have any questions.

Very truly yours,

Jeffrey W. Struble, P.E.

Jeffry W. Stratte

Mass. Reg. No. 32141

PROPOSED SINGLE FAMILY 62 KENSINGTON PARK ARLINGTON, MA FP. FP. SCALE: 1 IN = (20 FT)JULY 16, 2016 75.00' FENCE 18.0 102 DECK 55.0' 10.0 10.0 EXIST HOUSE & DRIVE TO BE REMOVED PROPOSED 2.5 STORY SINGLE FAMILY WIND WELL . 100 30.0 # 62 PROP FIRST FLOOR 101.6 HOUSE ROOF RIDGE 135.2 1 ST / 6 1 ST AVERAGE HOUSE GRADE 103.2 TREE(TYP) AVG GRADE AT SIDEWALK 96.5 LOT AREA: 6000 SF +/- REC LOT COVER: 26 % OPEN SPACE 65 % PROPOSED BIT DRIVEWAY 98 75.00 X96.8 X95.9 UTIL POLE X95.5 0 GAS WATER RIM 96.48 SEWER ESSEX ENG. & SURVEY PO BOX 620622 NEWTON LOWER FALLS MA. 02462-0622

REFERENCE: BOOK 67577 PAGE 134


PLAN BOOK 394 PLAN 23(LOT 7)

617-797-7342 EFAX: 617-663-6307


FRANK.IEBBA@GMAIL.COM

62 Kensing TON PACK 25.3% for Courage: 26 x 55 -1430 4 x 22,5 -Frueruse -1520 6000 -3793 GRANT Floor Arca - Briggent - 20×25 500 88 Front FC - 26x 33 858 147 LECONS Flow 1520 ATTSO (77'3") 680 TOTAL GFA -3793 1137.9 Den Space Requies
1875 Den Space Proxines
49.496 Open Space Persenage 34'6" Bulding Height (As Bush Requises)

* BANCO ON COT Slape > 5% 8.12 % DOCALL 95.5 - 102 6.5' DISTANCE 80.00 6 % +- Open Space 100 - 102 1.0 DISTANCE 25'

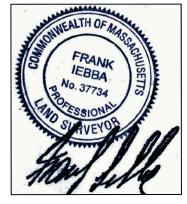

PROPOSED SINGLE FAMILY 62 KENSINGTON PARK ARLINGTON, MA SCALE: 1 IN = 20 FT JULY 16, 2016

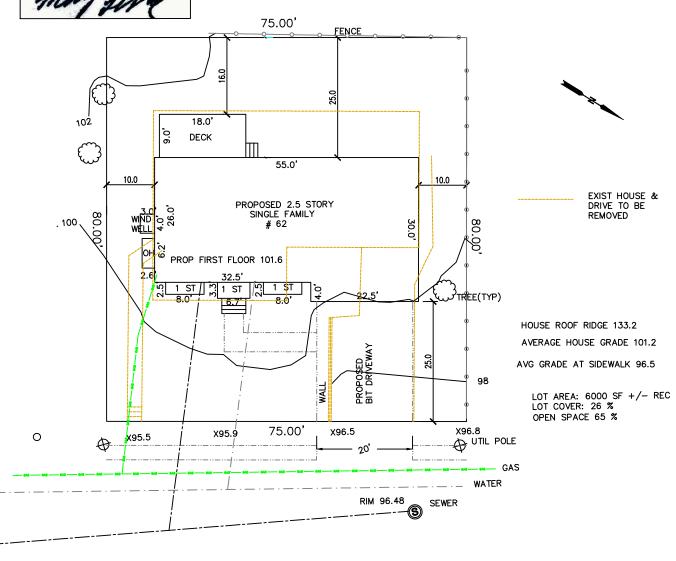

ESSEX ENG. & SURVEY PO BOX 620622 NEWTON LOWER FALLS MA. 02462-0622

REFERENCE: BOOK 67577 PAGE 134

PLAN BOOK 394 PLAN 23(LOT 7)

617-797-7342 EFAX: 617-663-6307

FRANK.IEBBA@GMAIL.COM

62 KENSINGTON PARK ARLINGTON, MA 02476

ZONING REVIEW


WORK TO BE COMPLETED IN ACCORDANCE TO: MASSACHUSETTS STATE BUILDING CODE ARLINGTON ZONING ORDINANCE


ZONING DISTRICT: R1
SINGLE FAMILY DETACHED DWELLING


| | REQUIRED | PROPOSED |
|------------------------------|----------|---|
| LOT SIZE MIN. | 6,000 | 6,000 |
| FRONTAGE | 60 | 75 |
| FRONT YARD SETBACK | 25 | 25 |
| SIDE YARD SETBACK | 10 | 10 |
| REAR YARD SETBACK | 20 | 25 |
| HEIGHT MAX. | 35 | 34'-5 3/8" (AVERAGE HEIGHT AT 4 CORNERS OF HOUSE) |
| | | LOT SLOPE 8.125% (SEE TOPO LINE AT CERTIFIED PLOT PLAN) |
| USABLE (% OF GROSS FL AREA) | 30% | 49% (REAR YARD OPEN SPACE: 25X75=1,875 SF) |
| IMPERVIOUS AREA NET INCREASE | 350 SF | *NO NET IMPERVIOUS AREA NET INCREASE |
| | | *THE FOOTPRINT OF THE PROPOSED HOUSE IS SMALLER THAN EXISTING HOUSE |
| | | *EXISTING REAR YARD STONE PATIO (TO BE DEMOLISHED) AND DRIVEWAY COMBINED IS |
| | | LARGER THAN PROPOSED DRIVEWAY AND ENTRANCE WALKWAY |


SQUARE FOOTAGE SUMMARY

| BASEMENT | 652 |
|------------------------|----------|
| 1ST FLOOR | 1061 |
| 2ND FLOOR | 1499 |
| ATTIC | 565 |
| TOTAL GROSS FLOOR AREA | 3,777 SF |

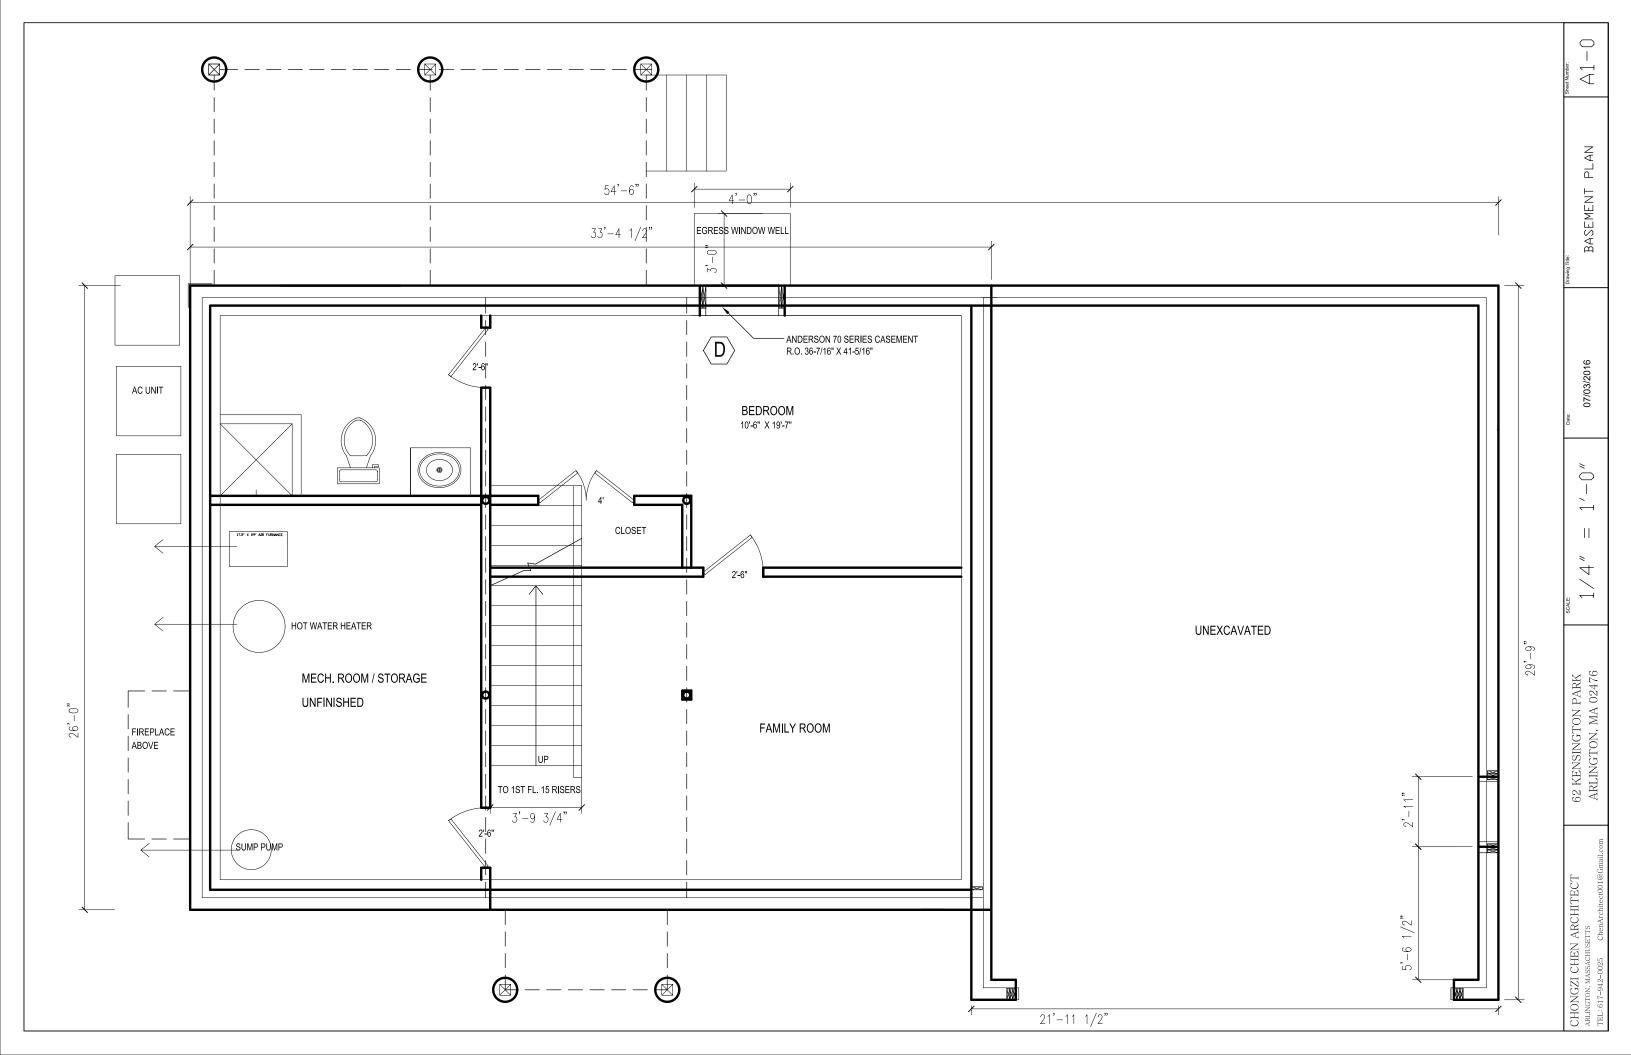


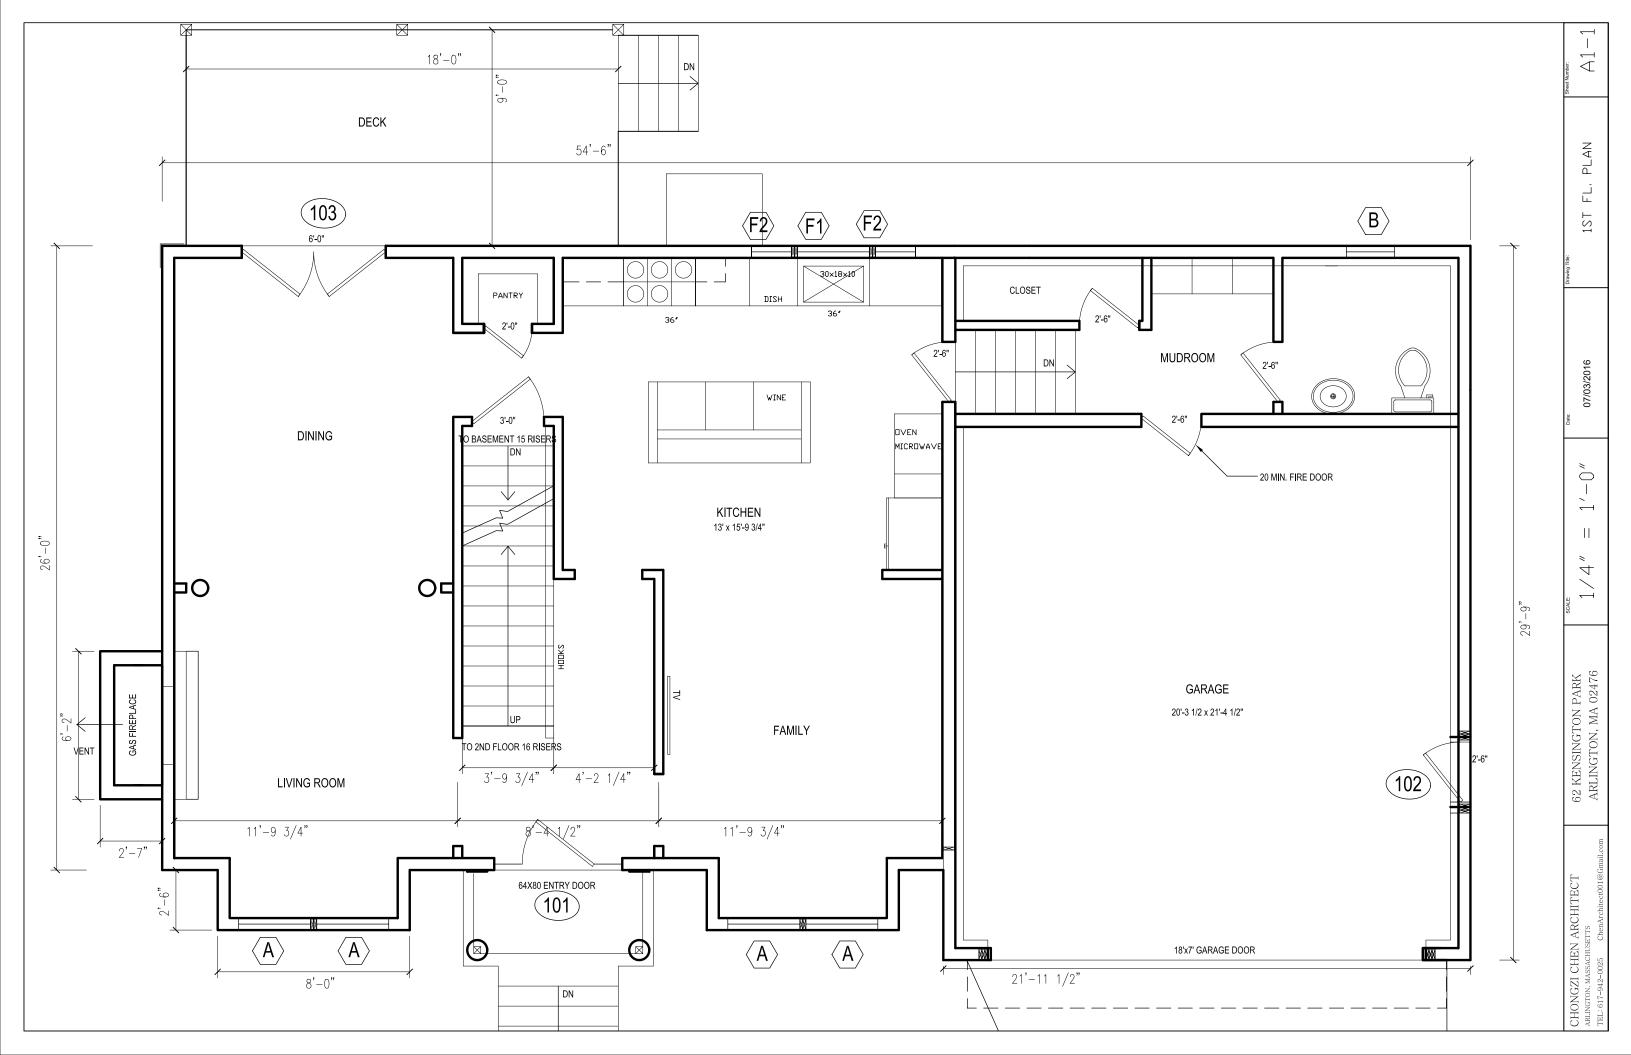


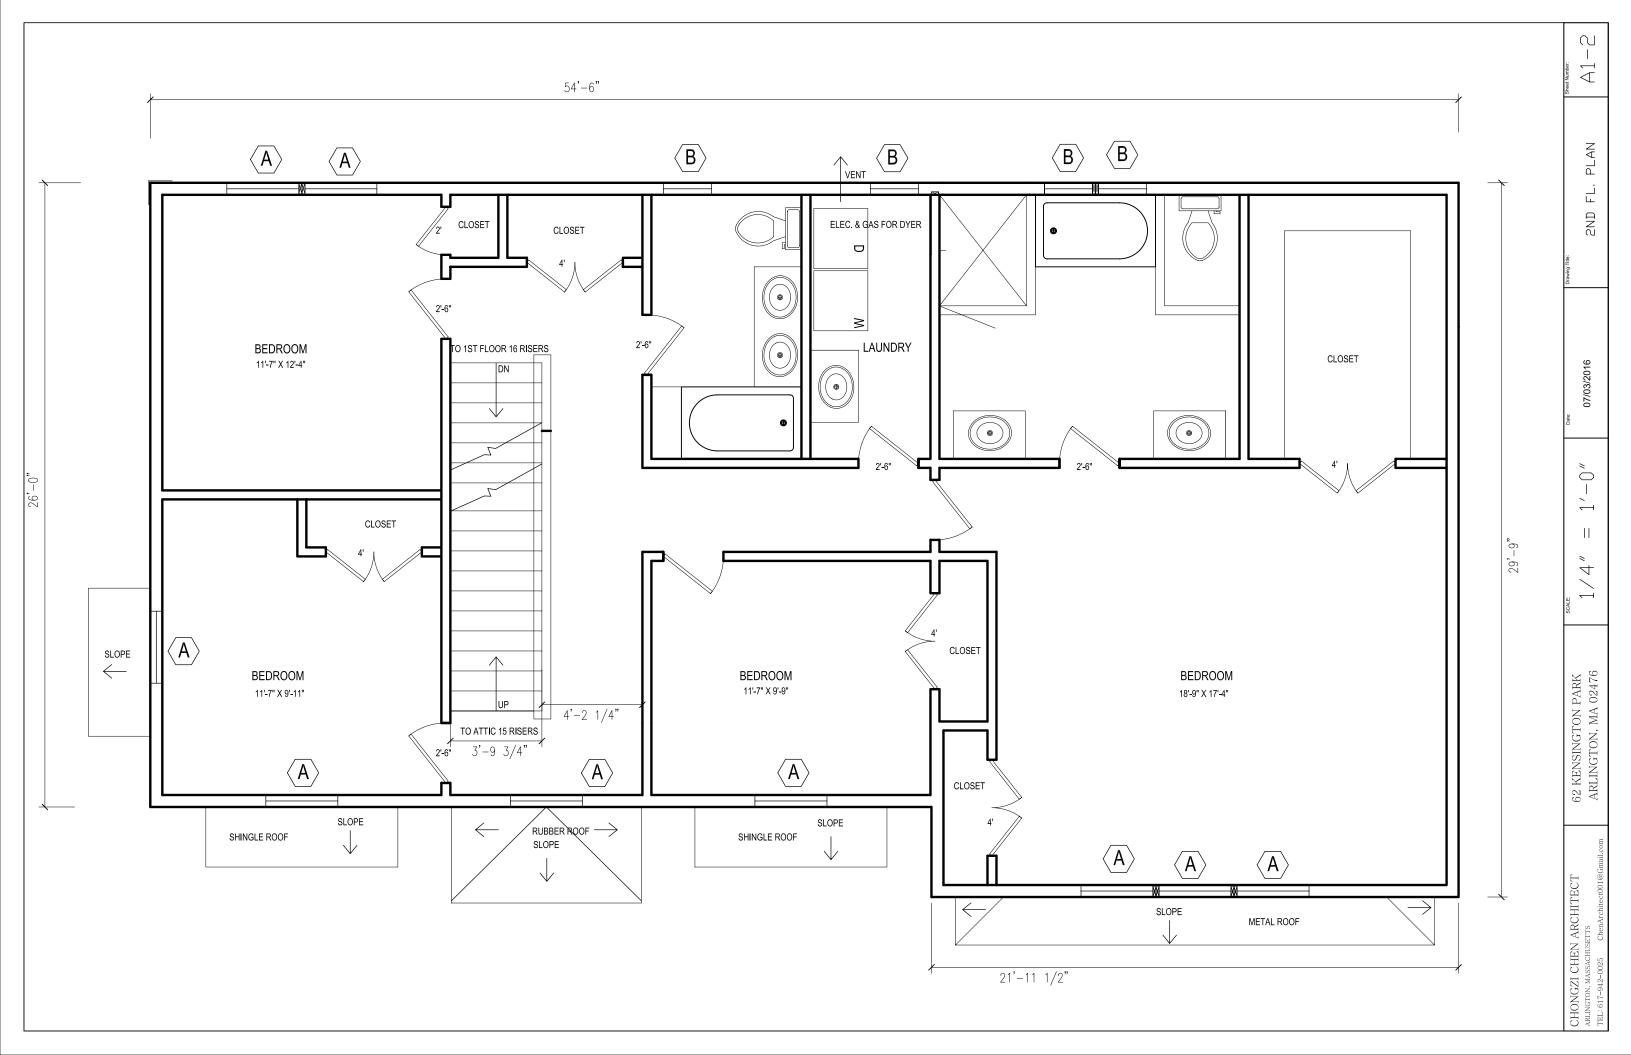


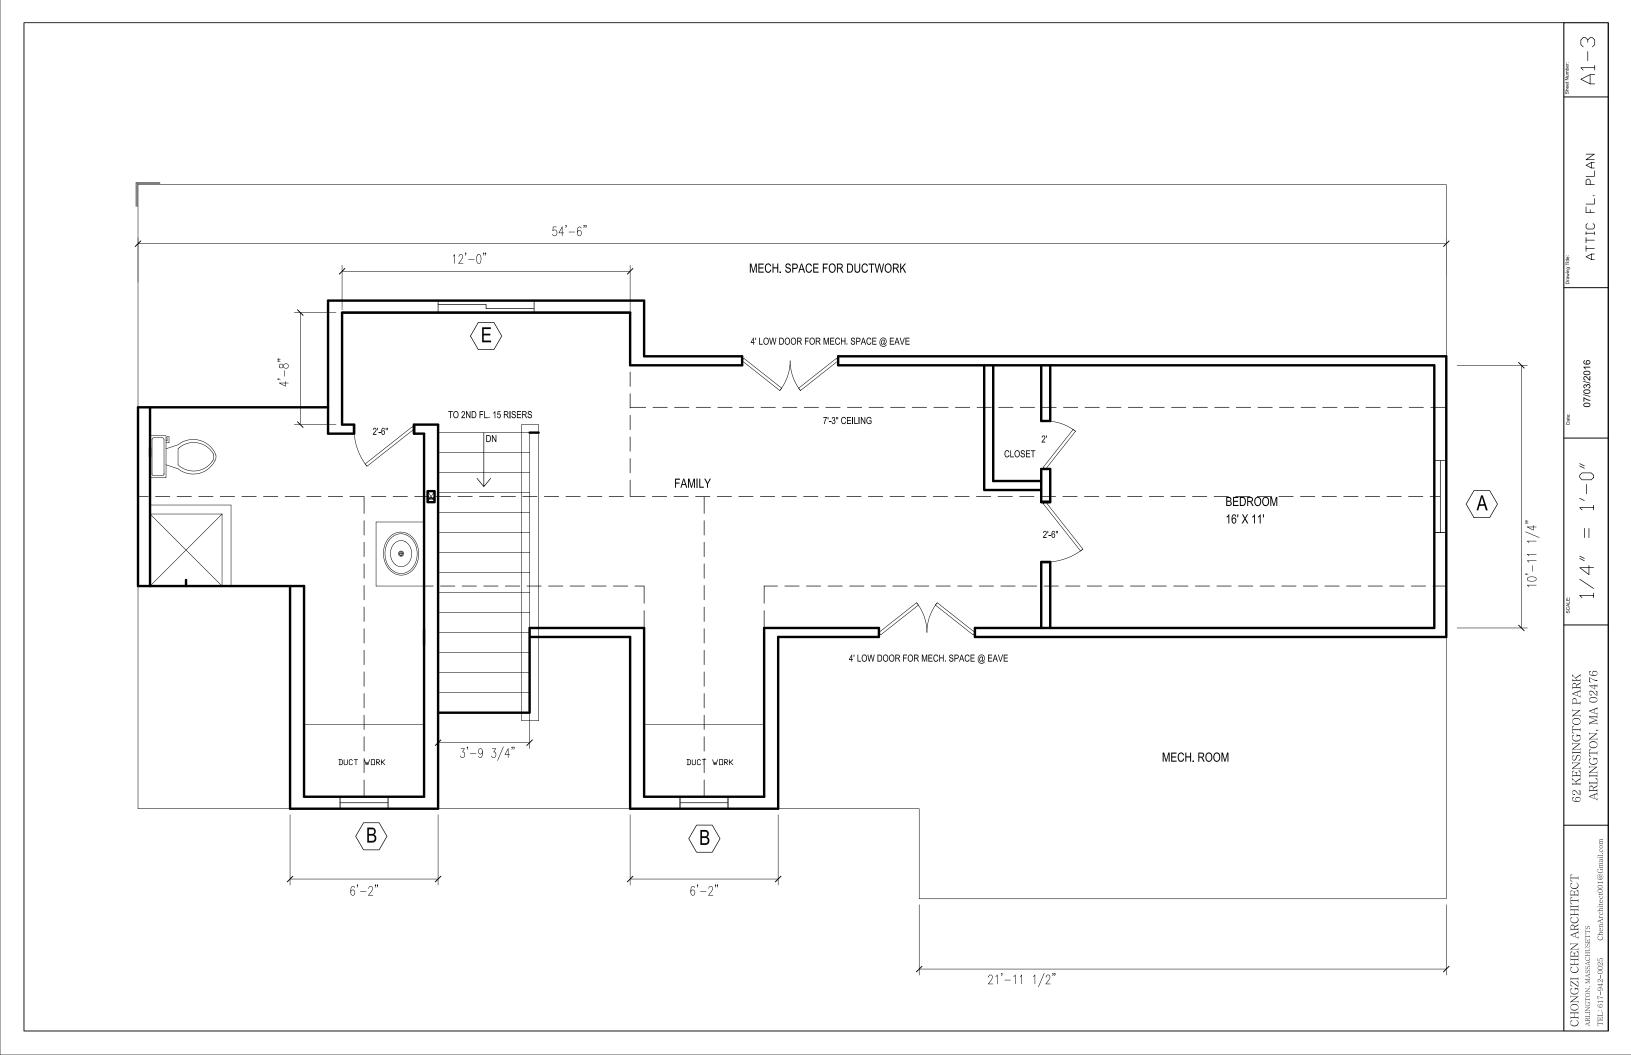



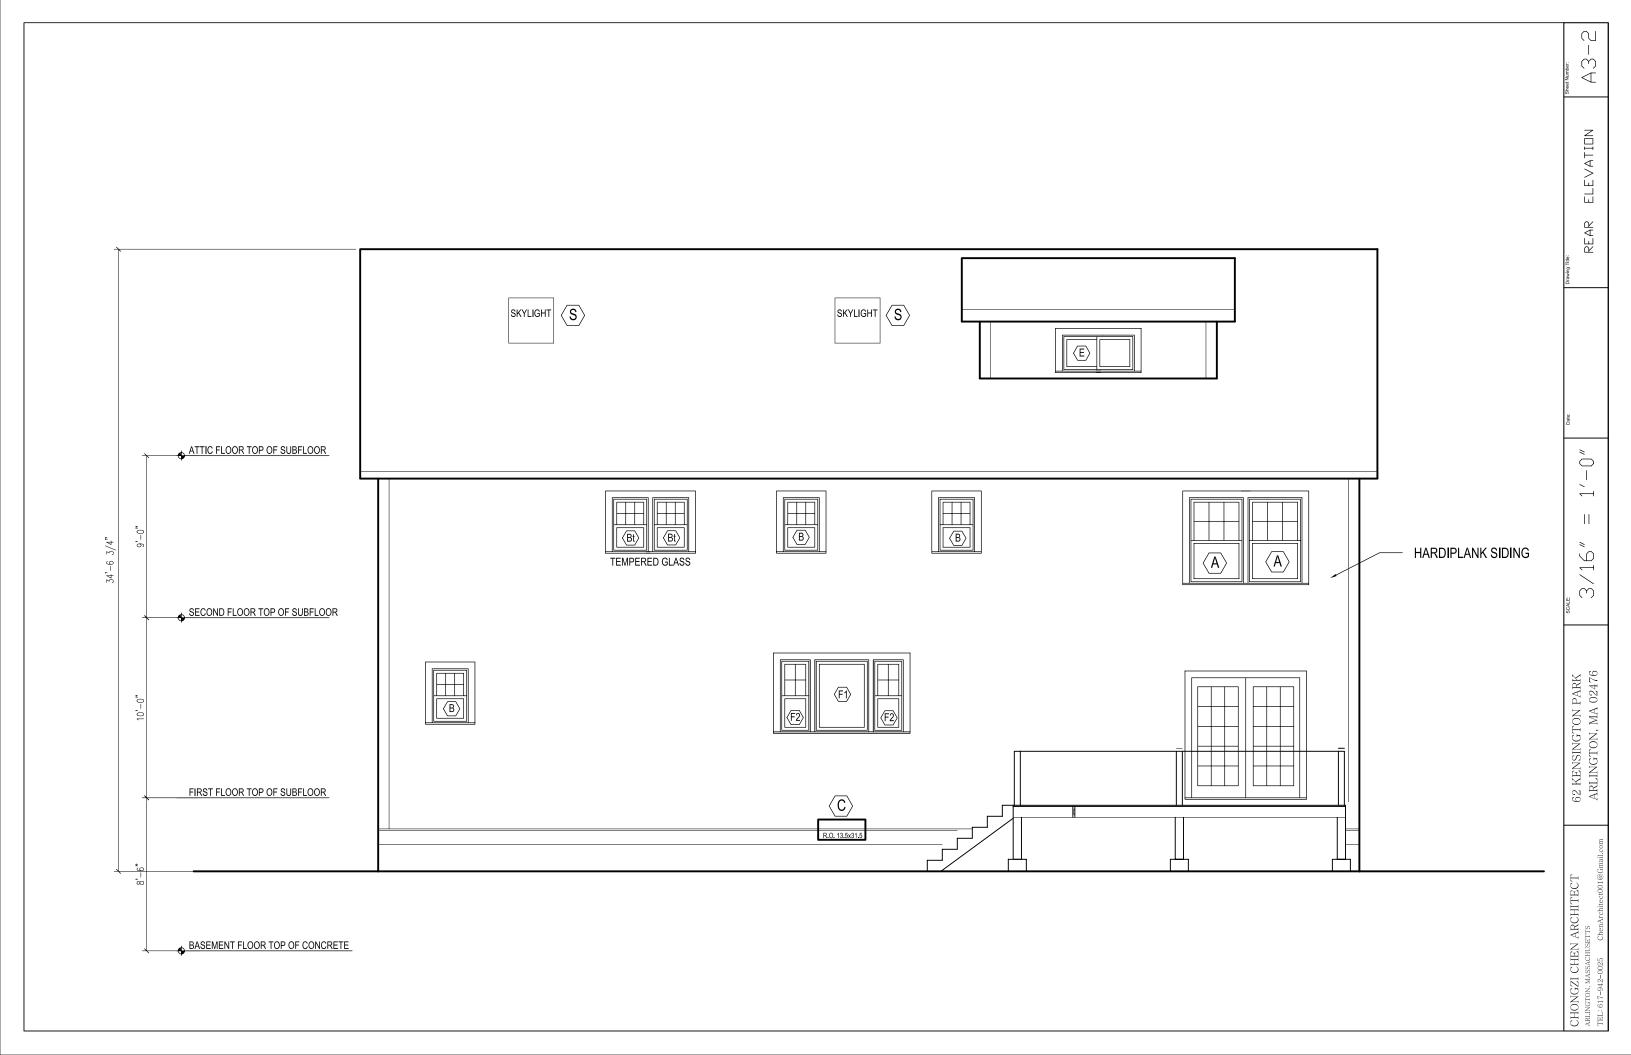

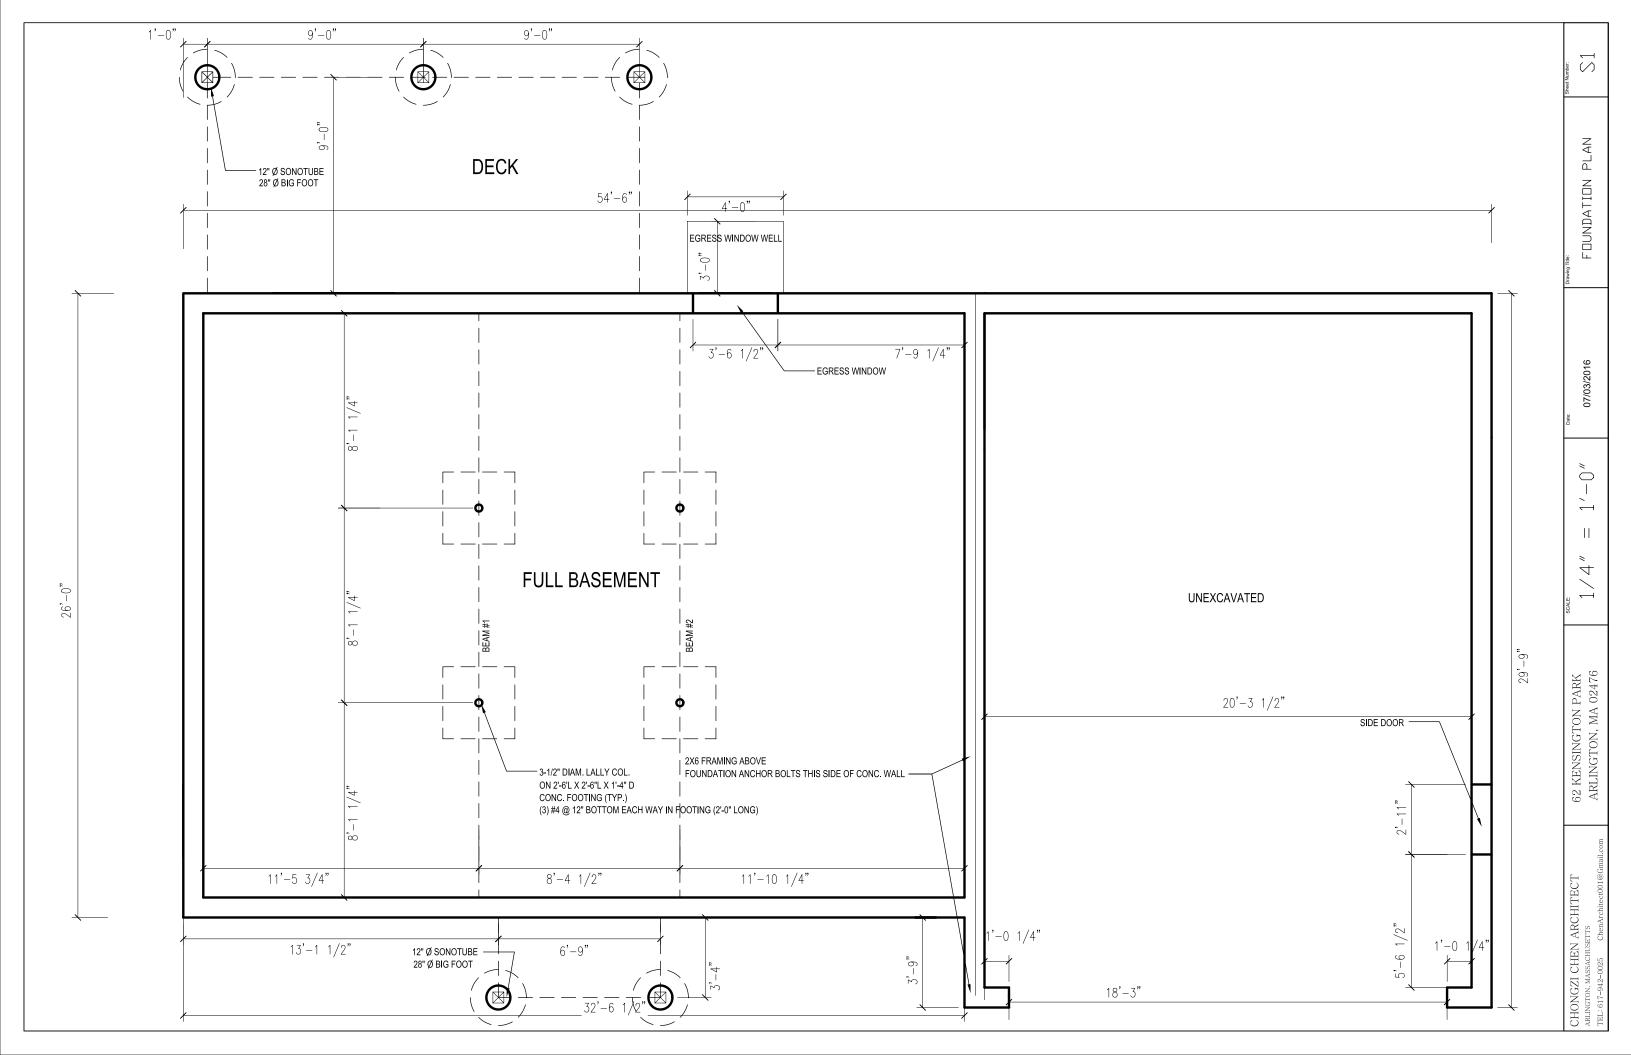

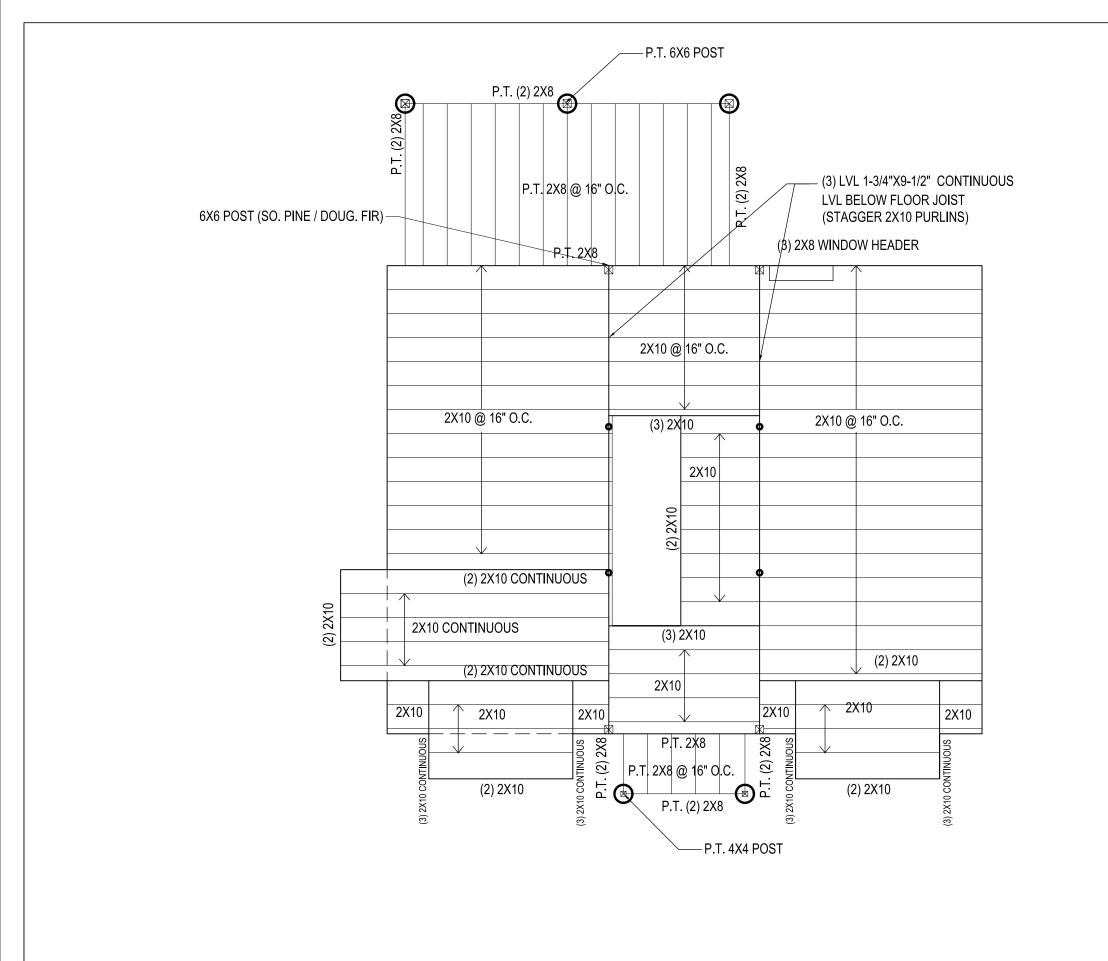

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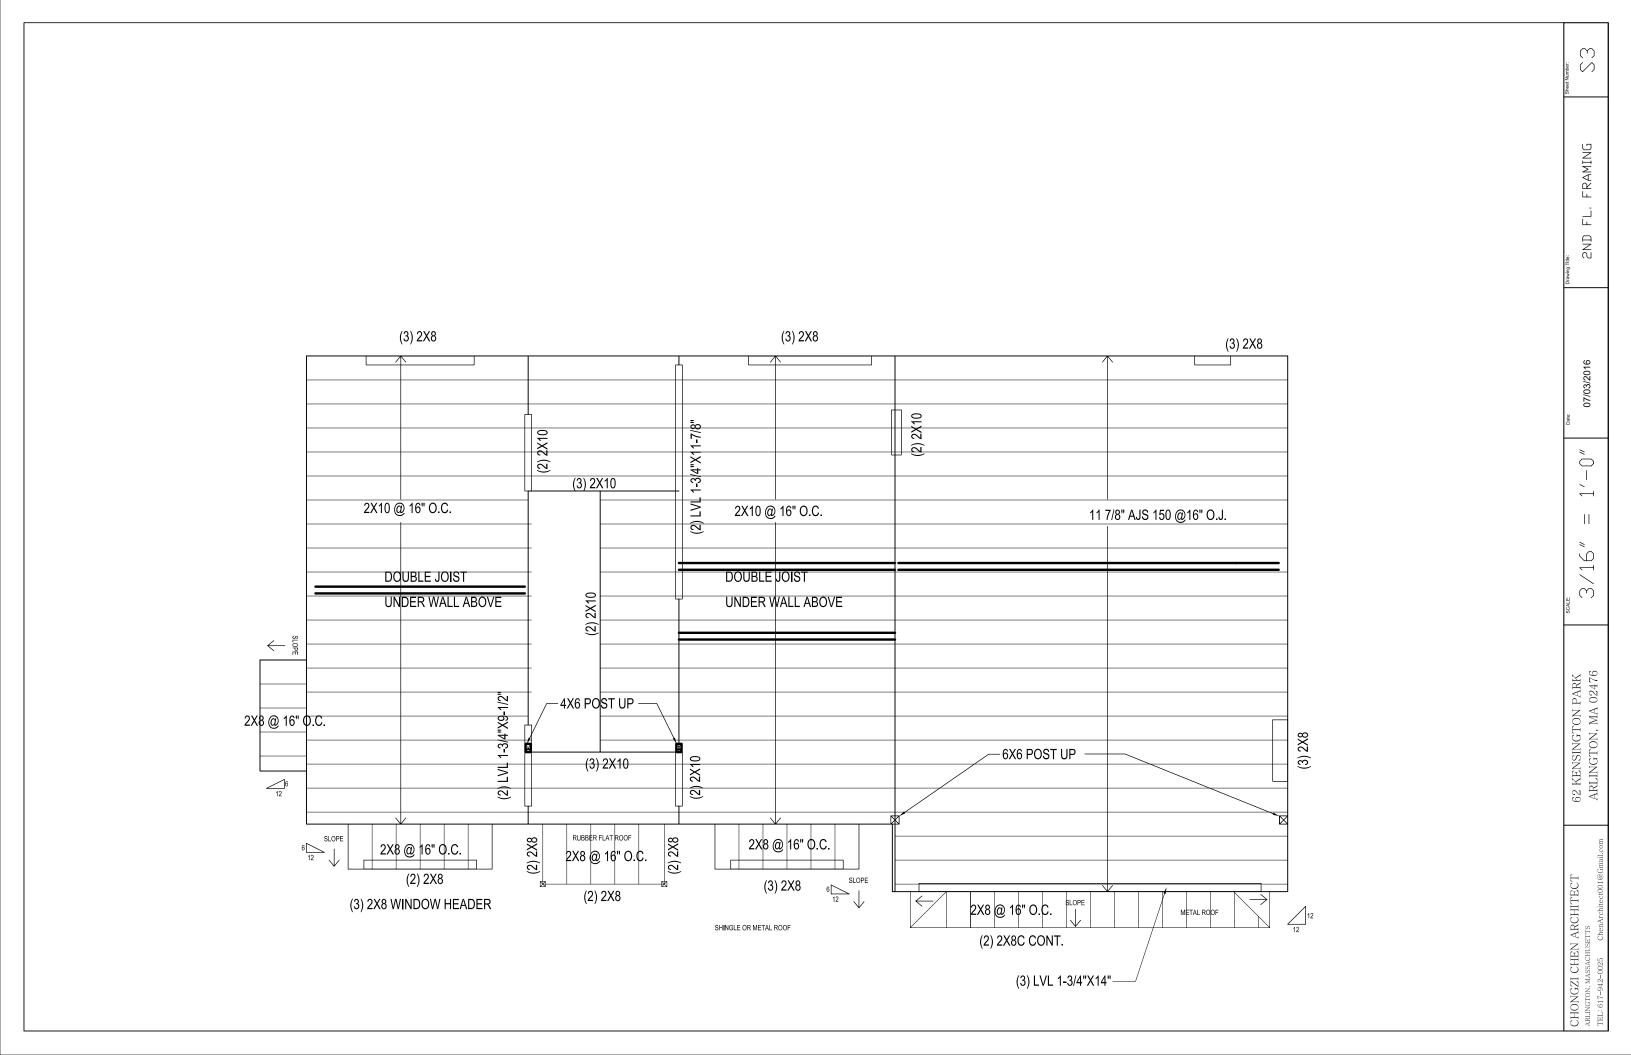
FL, FRAMING


07/03/2016

 $^{"}\bigcirc \parallel$ /16" $\stackrel{\cdot}{m}$

62 KENSINGTON PARK ARLINGTON, MA 02476

CHONGZI CHEN ARCHITECT
ARLINGTON, MASSACHUSETT'S



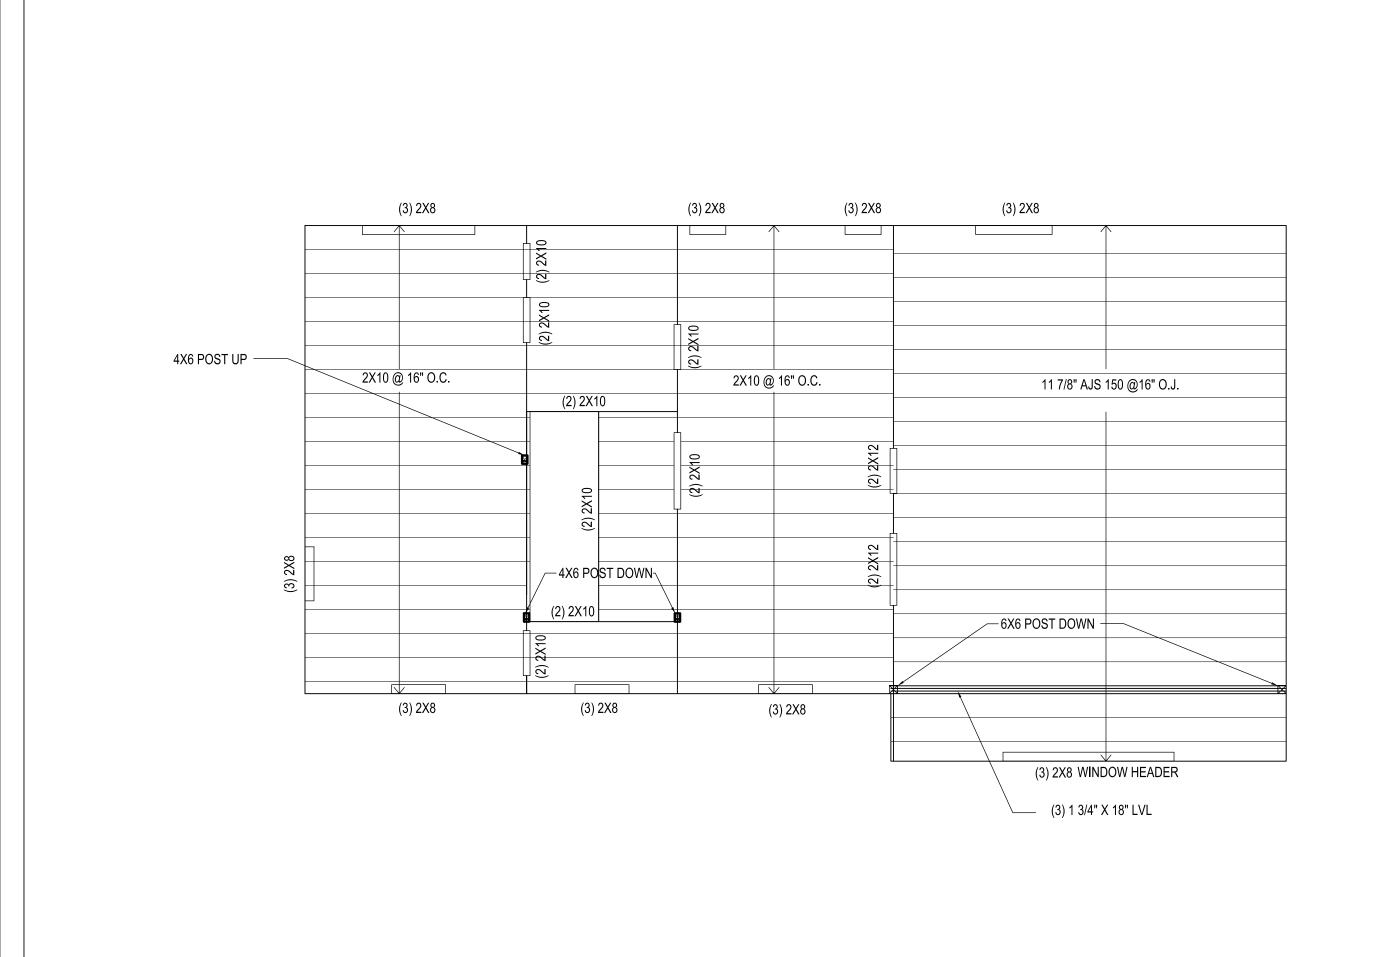

\$ 4

FRAMING

ATTIC/CEILING


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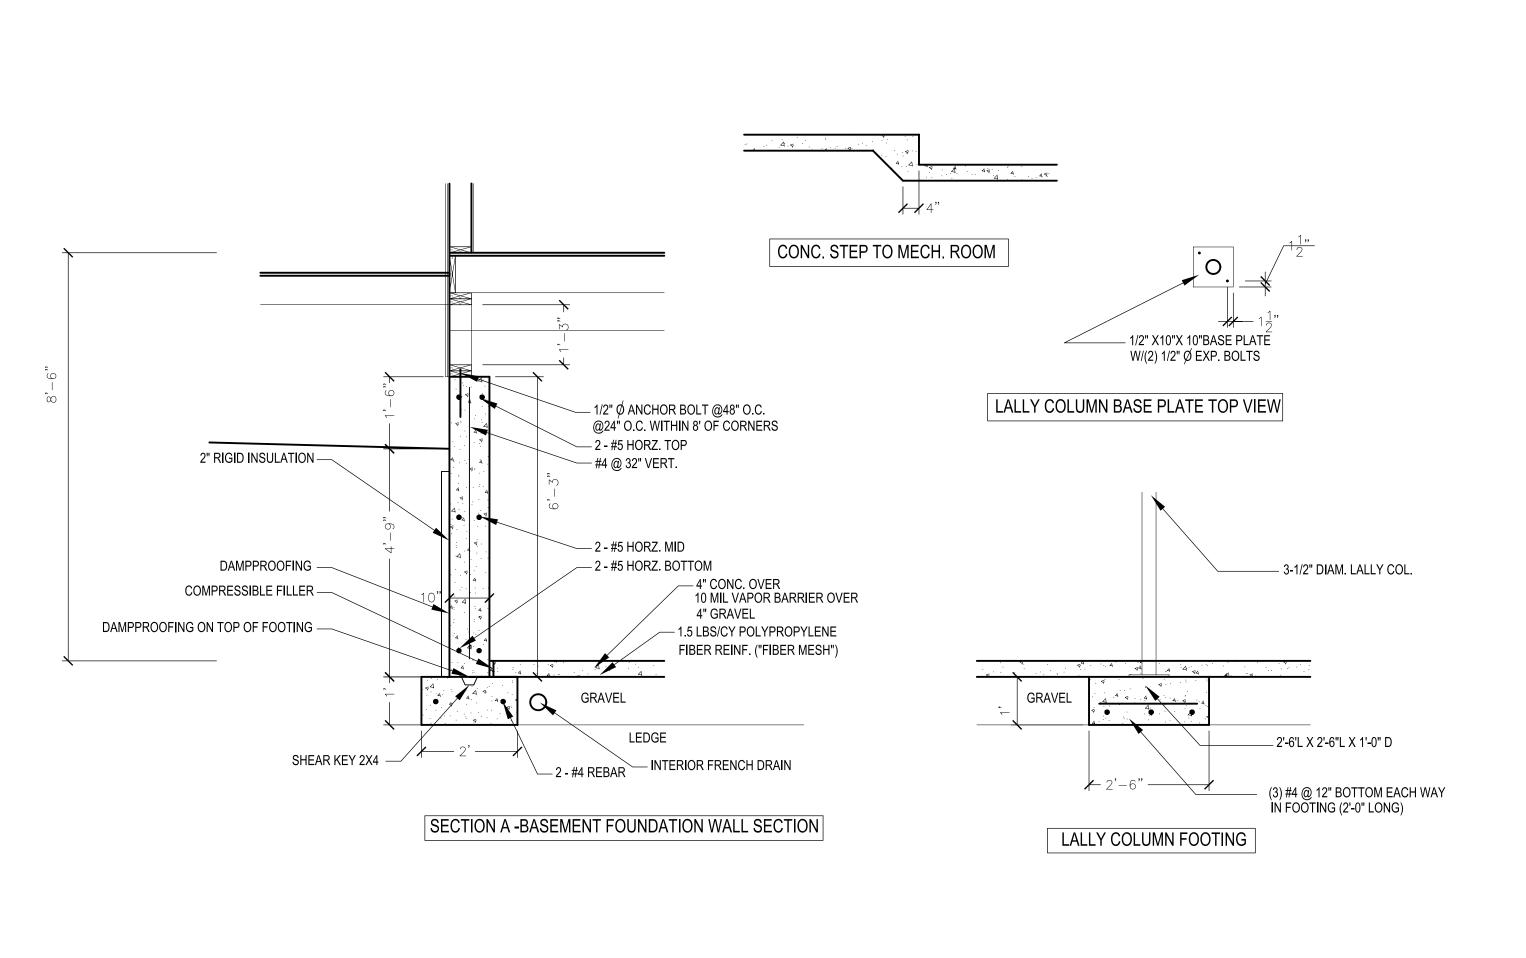
1'-0"

3/16"

62 KENSINGTON PARK ARLINGTON, MA 02476

CHONGZI CHEN ARCHITECT
ARLINGTON, MASSACHUSETTS



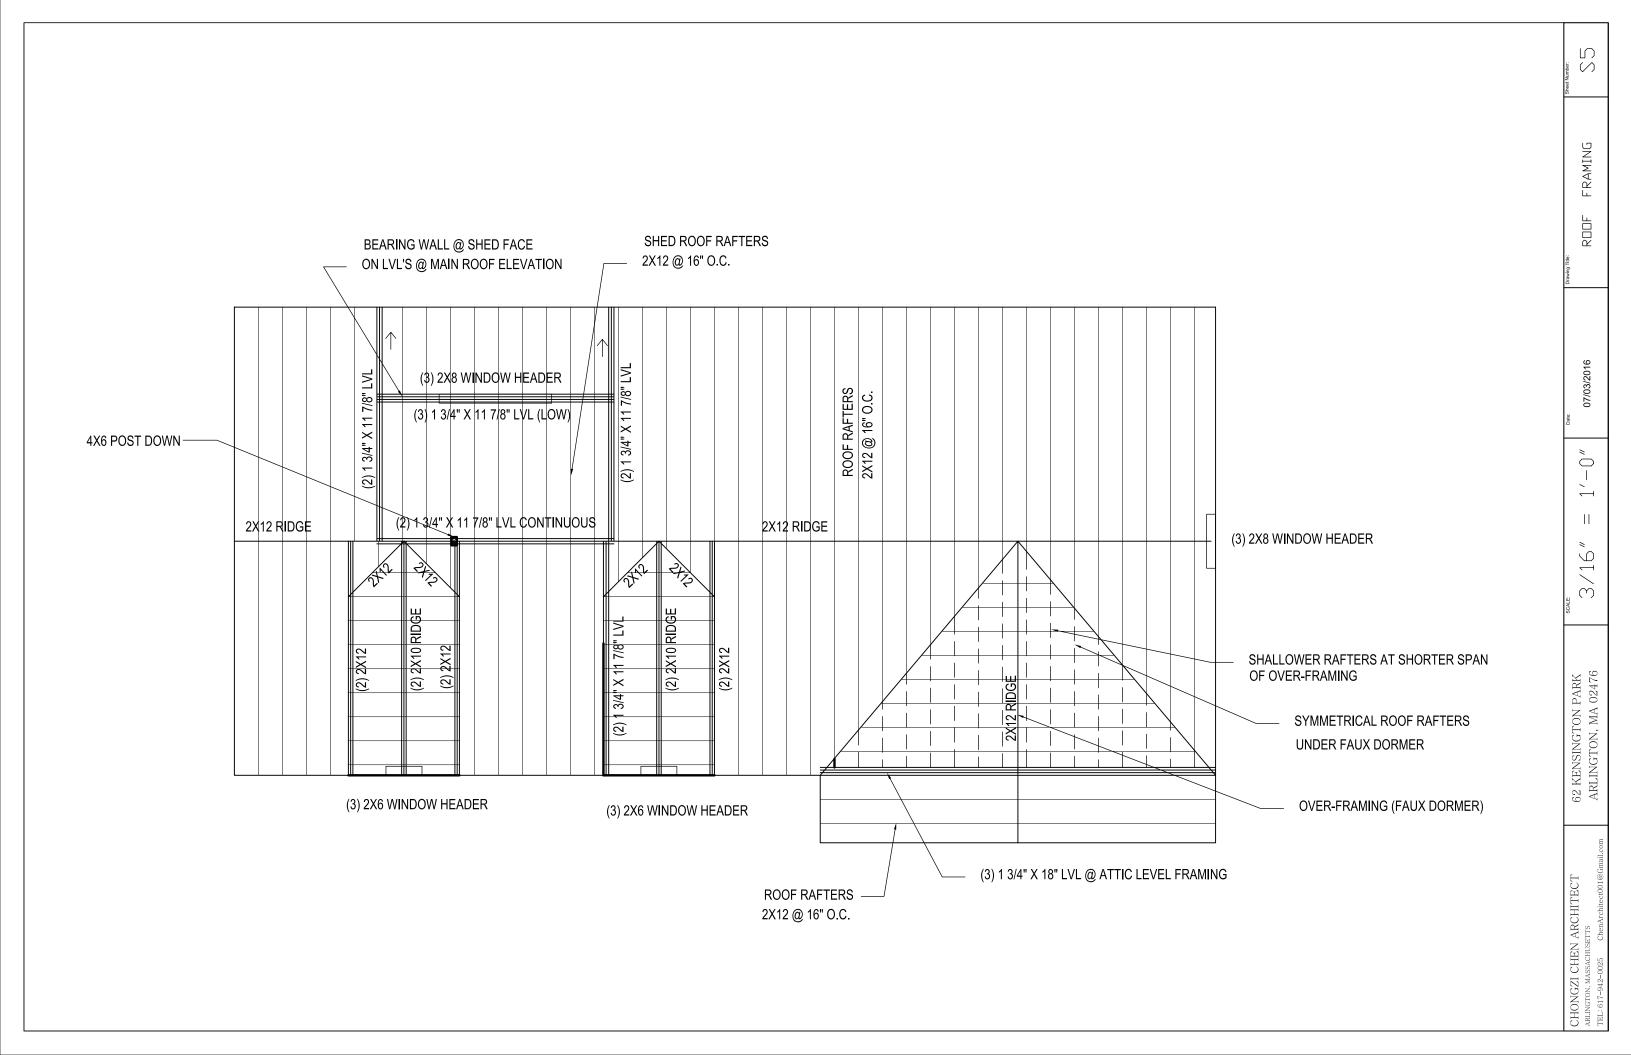

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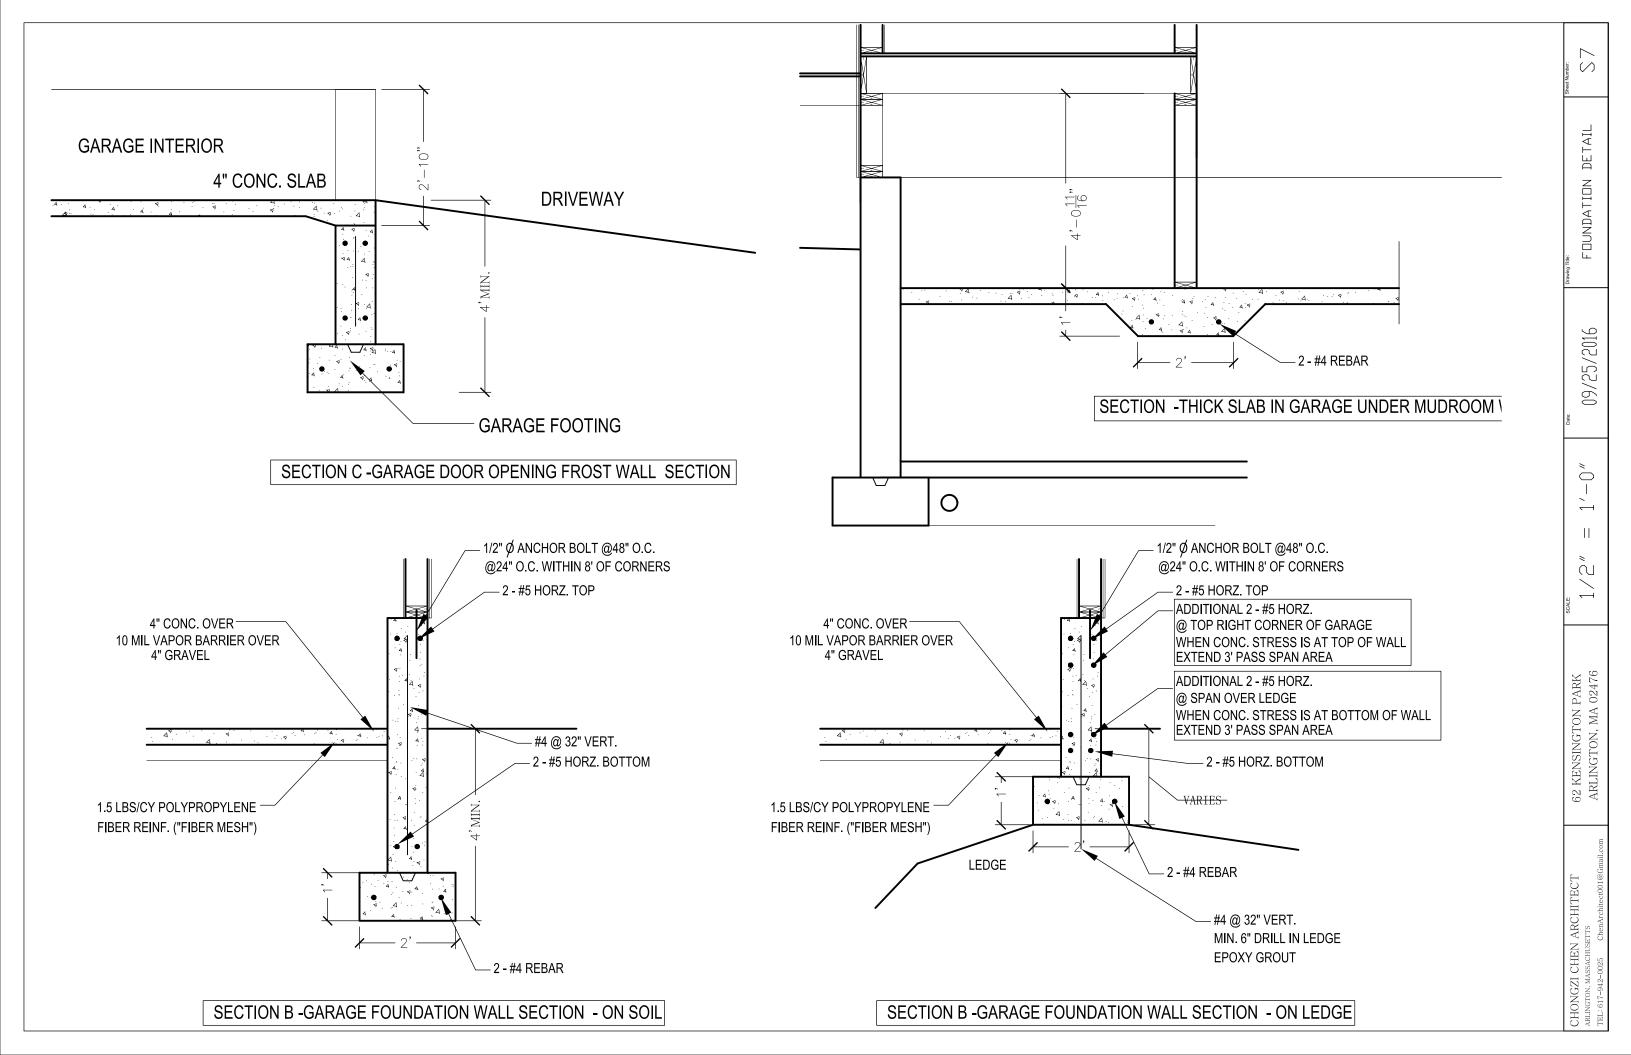
DETAIL FOUNDATION

09/25/2016

 $^{"}$ ù

62 KENSINGTON PARK ARLINGTON, MA 02476

CHONGZI CHEN ARCHITECT ARLINGTON, MASSACHITEFTTE



9-11 PARK STREET

DEMOLITION OF SINGLE FAMILY DWELLING, CONSTRUCTION OF NEW TWO FAMILY DWELLING.

| LOT COVERAGE: | 19.79% |
|------------------------------|--------------|
| TOTAL GROSS FLOOR AREA: | 3413.5 SQ FT |
| OPEN SPACE REQUIRED: | 1324 SQ FT |
| OPEN SPACE PROVIDE: | 3377 SQ FT |
| OPEN SPACE PERCENTAGE: | 76.52% |
| BUILDING HEIGHT (PROPOSED) | 33' +/- |
| LOT SLOPE: (OVERALL) | 1.67% |
| LOT SLOPE: (OPEN SPACE ONLY) | 1.42% +/- |
| ATTIC GFA (680 SQ FT) | 47.18 % |
| SLOPE OF DRIVEWAY PROPOSED | 13 % |


| | 9-11 Pacx Sacor |
|-------------------|---|
| 19.79 % | Lot Courage Lavonce 385 x 42 1617 Lot 8169 |
| 4413.5 M | Glass Flan Aces Broger 8x 26 = 208 8x 26 = 208 |
| | Frust Floor Second Floor ATTIC (773" ceiling) |
| | 11 x 38 5 423.5 3x 12 36 |
| 1324 0 | Open Legures (4413.5 x .36) |
| 3377 × 76.52 % | Open Same Person (Area 56.25 x 60.04) Open Same Person rage |
| 33' +/- | Building HergHT (As Boilt Regulars) Brases ON COT Stope 2 5 96 |
| 1.67 % 1.42 × | LOT Stope: 608ALC 30.7 - 33.0 2'3 DISMACE 137.25 Open Space: 32.2 - 33.0 08 DISMACE 56.25 |
| 47.18 % | ATTIC GFA Personage (763) |



Town of Arlington
Inspectional Services Department
51 Grove Street
Arlington, Massachusetts 02476
781-316-3390
www.arlingtonma.gov

As built plot plan requirements prior to issuance of Certificate of Occupancy

| As deemed necessary by the Building Official, the following may be required for review as p certified plot plan prior to issuance: | art of the |
|--|--------------|
| | |
| Building Height - (max 35' from average grade of structure in lots with slope of 5% grade of 5 | rade or |
| more.) Stories - calculations showing measurements for stories. (basement and attic) | |
| Gross Floor Area - calculations showing total GFA as defined in Zoning Bylaw. | |
| Open Space - calculations showing required usable and open space requirements ba | sed on total |
| Parking spaces - show placement of required spaces. | . 5.7 |
| Cyce | 1 |
| | |

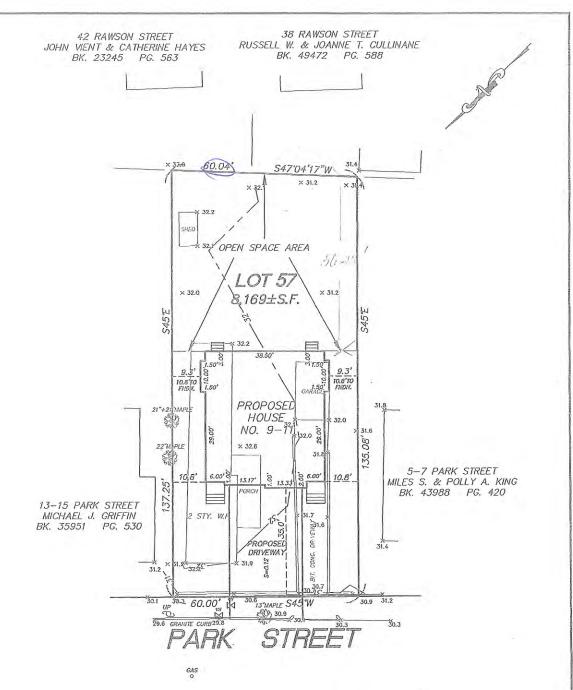

NOTES:

WATER SERVICE TO BE 1" TYPE "K" COPPER.

2) SEWER SERVICE TO BE 6" PVC.

3) WATER AND SEWER LATERALS SHALL BE 10' APART (min).
 4) PROPOSED WATER TO BE CONNECTED TO EXISTING SERVICE.

5) PROPOSED SEWER TO BE CONNECTED TO EXISTING SERVICE.

LOT LOCATED IN FLOOD ZONE C. MAP 25017CO417E.

PROPOSED BASEMENT FLOOR=26.2
PROPOSED FIRST FLOOR=35.0
EXISTING AVERAGE GRADE TOP CURB=30.5
PROPOSED PEAK = 62.1
MAX. PEAK = 65.5
PROPOSED GARAGE FLR.=26.2
EXISTING BUILDING COVER= 16.0%
PROPOSED BUILDING COVER= 20.5%

I CERTIFY THAT THE BUILDINGS ARE LOCATED AS SHOWN AND THAT THIS PLOT PLAN IS THE RESULT OF AN

USABLE OPEN SPACE = 3430S.F.=42%

INSTRUMENT SURVEY.



OWNER: DOROTHY E. HENDER BK. 36671 PG. 264

PROPOSED PLAN
IN
ARLINGTON, MASS.

SCALE: 1 IN. = 20 FT.

JUNE 16, 2016

8 WINCHESTER PLACE, SUITE 208
WINCHESTER, MASS. 01890
781-729-4213

